
DIAMOND OPTICAL CARE OF FENTON 1331 N. LEROY ST, FENTON, MI 48430

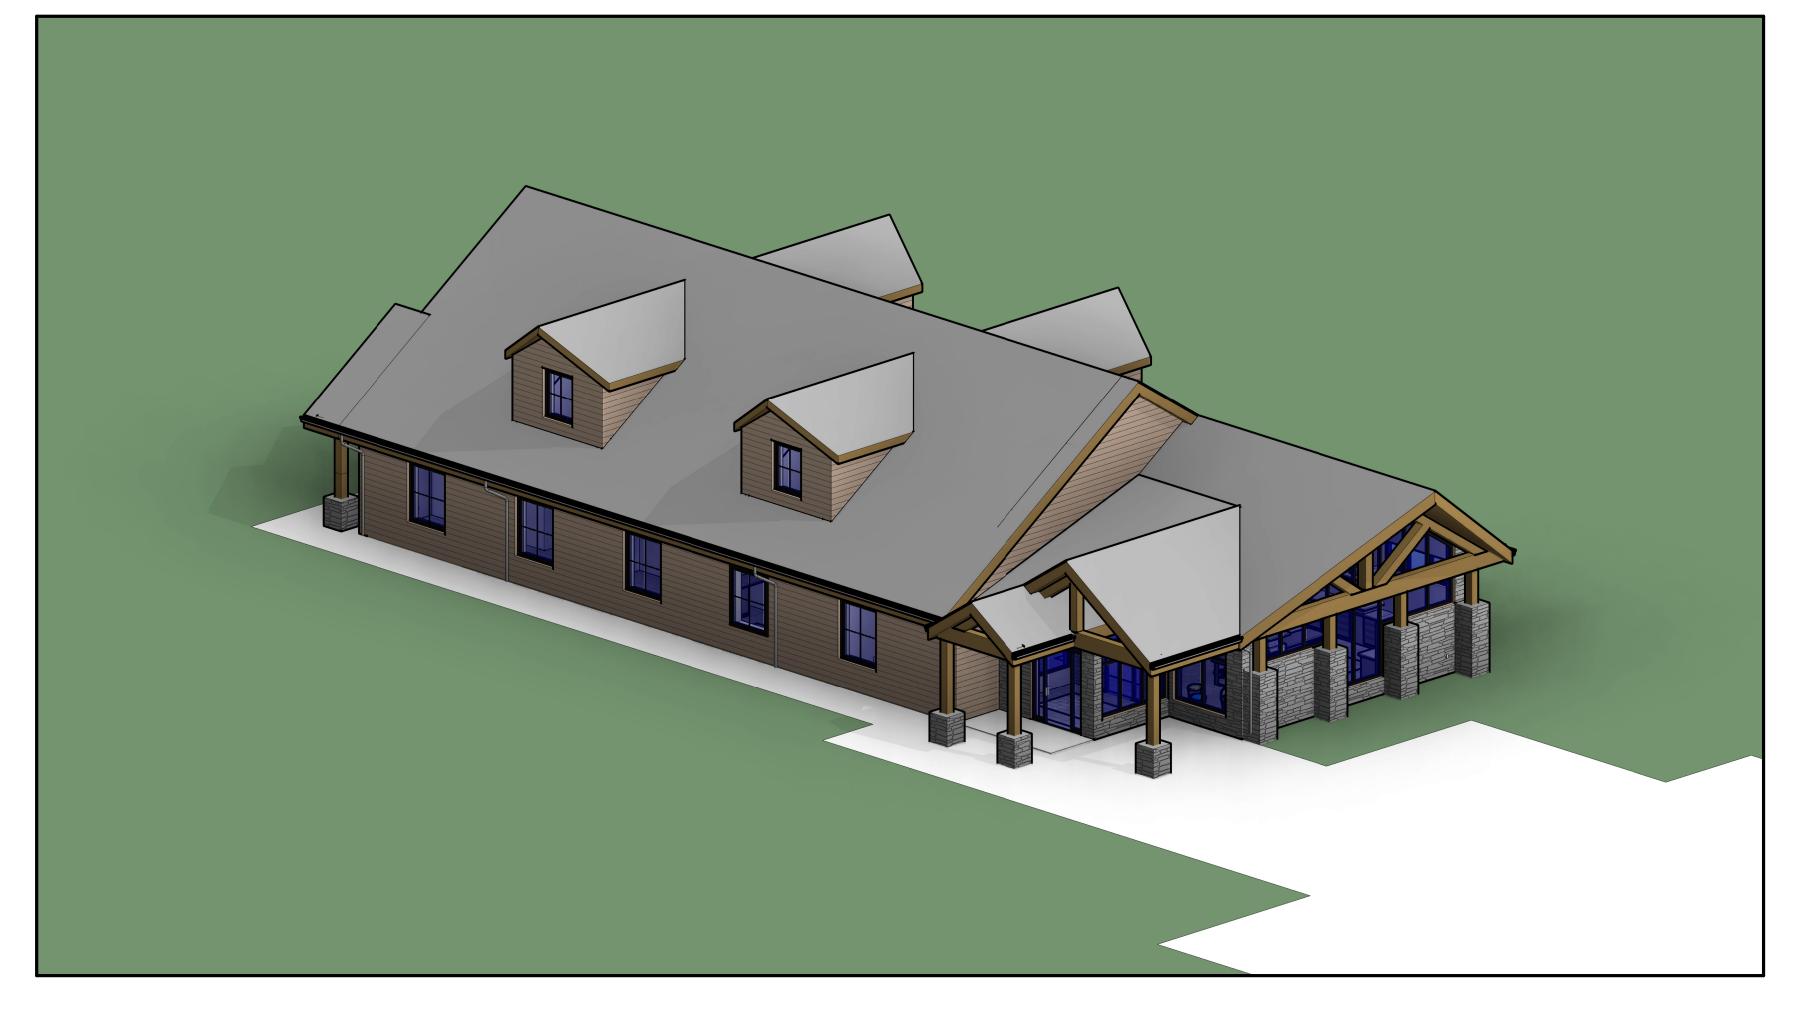



PROJECT TEAM

ARCHITECT OWNER

SEDGEWICK + FERWEDA ARCHITECTS CONTACT: BRIANNA FULLER, AIA 410 EAST COURT STREET FLINT, MICHIGAN 48503 T: 810-238-9647 BRIANNA@SFARCH.US JOSEPH M. LEPPEK O.D 16528 HILAND TRAIL FLINT, MICHIGAN 48451 810-341-3900 LEPPEK.JOSEPH@GMAIL.COM

BUILDING DATA

TOTAL GROSS BUILDING AREA: 4,907 SQ. FT USE GROUP: B - BUSINESS BUILDING TYPE: 3B OCCUPANCY: 4,907/100 = 49 **REQUIERED EXITS: 2**

GENERAL PROJECT AND SITE

PARCEL ID: LOT SIZE: 0.6 ACRES

PARCEL ZONING: GBD - GENERAL BUSINESS DISTRICT

SETBACKS:

FRONT: 40' REAR: 25' SIDE: MINIMUM 10' COMBINED 25' EASEMENTS: NONE

BUILDING CODES

BUILDING CODES TO REFERENCE (CHECK ALL TO BE USED)

- MICHIGAN BUILDING CODE 2015 EDITION □ MICHIGAN RESIDENTIAL BUILDING CODE 2015 EDITION MICHIGAN REHABILITATION CODE 2015 EDITION - LEVEL 2
- MECHANICAL MICHIGAN MECHANICAL CODE 2015 EDITION PLUMBING - MICHIGAN PLUMBING CODE 2015 EDITION ELECTRICAL - NATIONAL ELECTRICAL CODE 2017 EDITION
- MICHIGAN ENERGY CODE ASHRAE 90.1-2013

DRAWING INDEX

☑ NFPA 101 LIFE SAFETY CODE 2015 EDITION

SHEET		
NO.	SHEET NAME	CURRENT REVISION
A0.0	Cover Page	1
C1.0	Topographic Survey	
	Site Layout Plan	
C1.2	Site Grading & Erosion Plan	
	Site Utility Plan	
C1.4	Site Details	
C1.5	Site Utility Details	
	Landscape Plan	
A0.1	General Notes	
A2.0	Foundation Plan	1
A2.1	Proposed First Floor Plan	1
A2.2	Proposed Second Floor Plan	1
A2.3	Reflected Ceiling Plans	1
	Roof Framing Plans	1
	Bldg Framing Sections	1
A2.6	Roof Plan	1
A3.0	Exterior Elevations	
A4.0	Building Sections	1
A5.0	Interior Elevations	
A5.1	Interior Elevations	
A5.2	Interior Elevations	
A6.1	Finish Plans	1
A8.0	Details	1
P1.0	Plumbing Plans	1
M1.0	Mechanical Plans	1
M1.1	Mechanical Details	1
E1.0	Electrical Plans	1
E2.0	Lighting Plans	1



Street

410 East EL: 810-23

HITECT

t Court 38-964 В




GENERAL NOTES

- 1. DO NOT SCALE DRAWINGS. USE FIGURED DIMENSIONS ONLY. 2. CONTRACTOR SHALL VERIFY ALL DIMENSIONS PRIOR TO ANY WORK.
- 3. ALL WORK SHALL CONFORM TO ALL GOVERNING CODES AND REGULATIONS.

KEY TO DIMENSIONING: DIMENSIONS SHOWN ARE FROM ROUGH STUD FACE TO ROUGH STUD FACE, ROUGH FACE TO COLUMN CENTERLINE, AND COLUMN CENTERLINE TO COLUMN CENTERLINE, UNLESS NOTED OTHERWISE.


OWNERSHIP OF DRAWINGS

ALL PLANS, DRAWINGS, AND SPECIFICATIONS (THE DOCUMENTS) ARE INSTRUMENTS OF SERVICE AND SHALL REMAIN THE PROPERTY OF THE ARCHITECT WHETHER THE PROJECT FOR WHICH THEY WERE MADE IS EXECUTED OR NOT. OWNER SHALL NOT USE THE DOCUMENTS ON OTHER PROJECTS FOR EXTENSIONS OR ADDITIONS TO THE PROJECT, OR FOR THE COMPLETION OF THE PROJECT BY OTHER EXCEPT IN AGREEMENT IN WRITING AND WITH APPROPRIATE COMPENSATION TO THE DESIGNER. THE OWNER SHALL HOLD THE ARCHITECT HARMLESS FROM ALL CLAIMS, ACTIONS, CAUSE OF ACTIONS, LIABILITY, LOSSES, DAMAGES, COST AND EXPENSE, INCLUDING ATTORNEY'S FEES AND COSTS ARISING FROM SUCH UNAUTHORIZED USE. REPRODUCTION COPIES CAN BE PROVIDED AT THE OWNERS REQUEST AND EXPENSE.

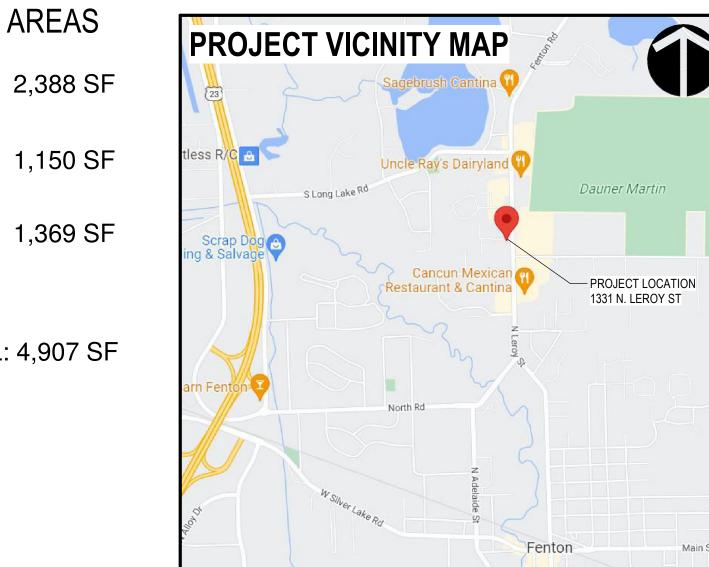



REVISIONS 11/21/22 Revision 1 Date Description



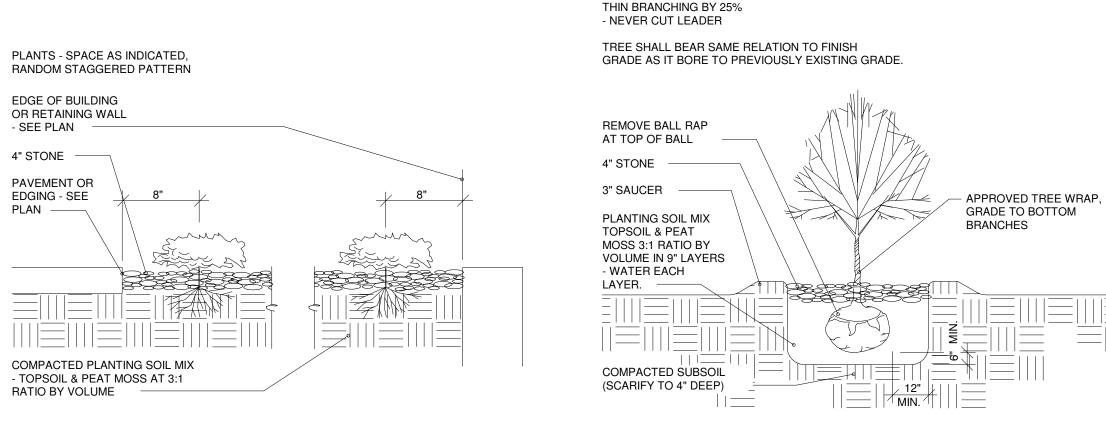



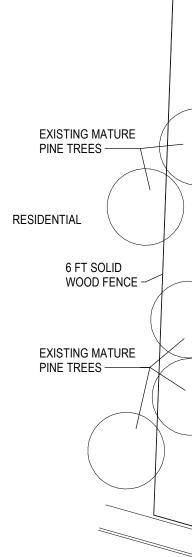

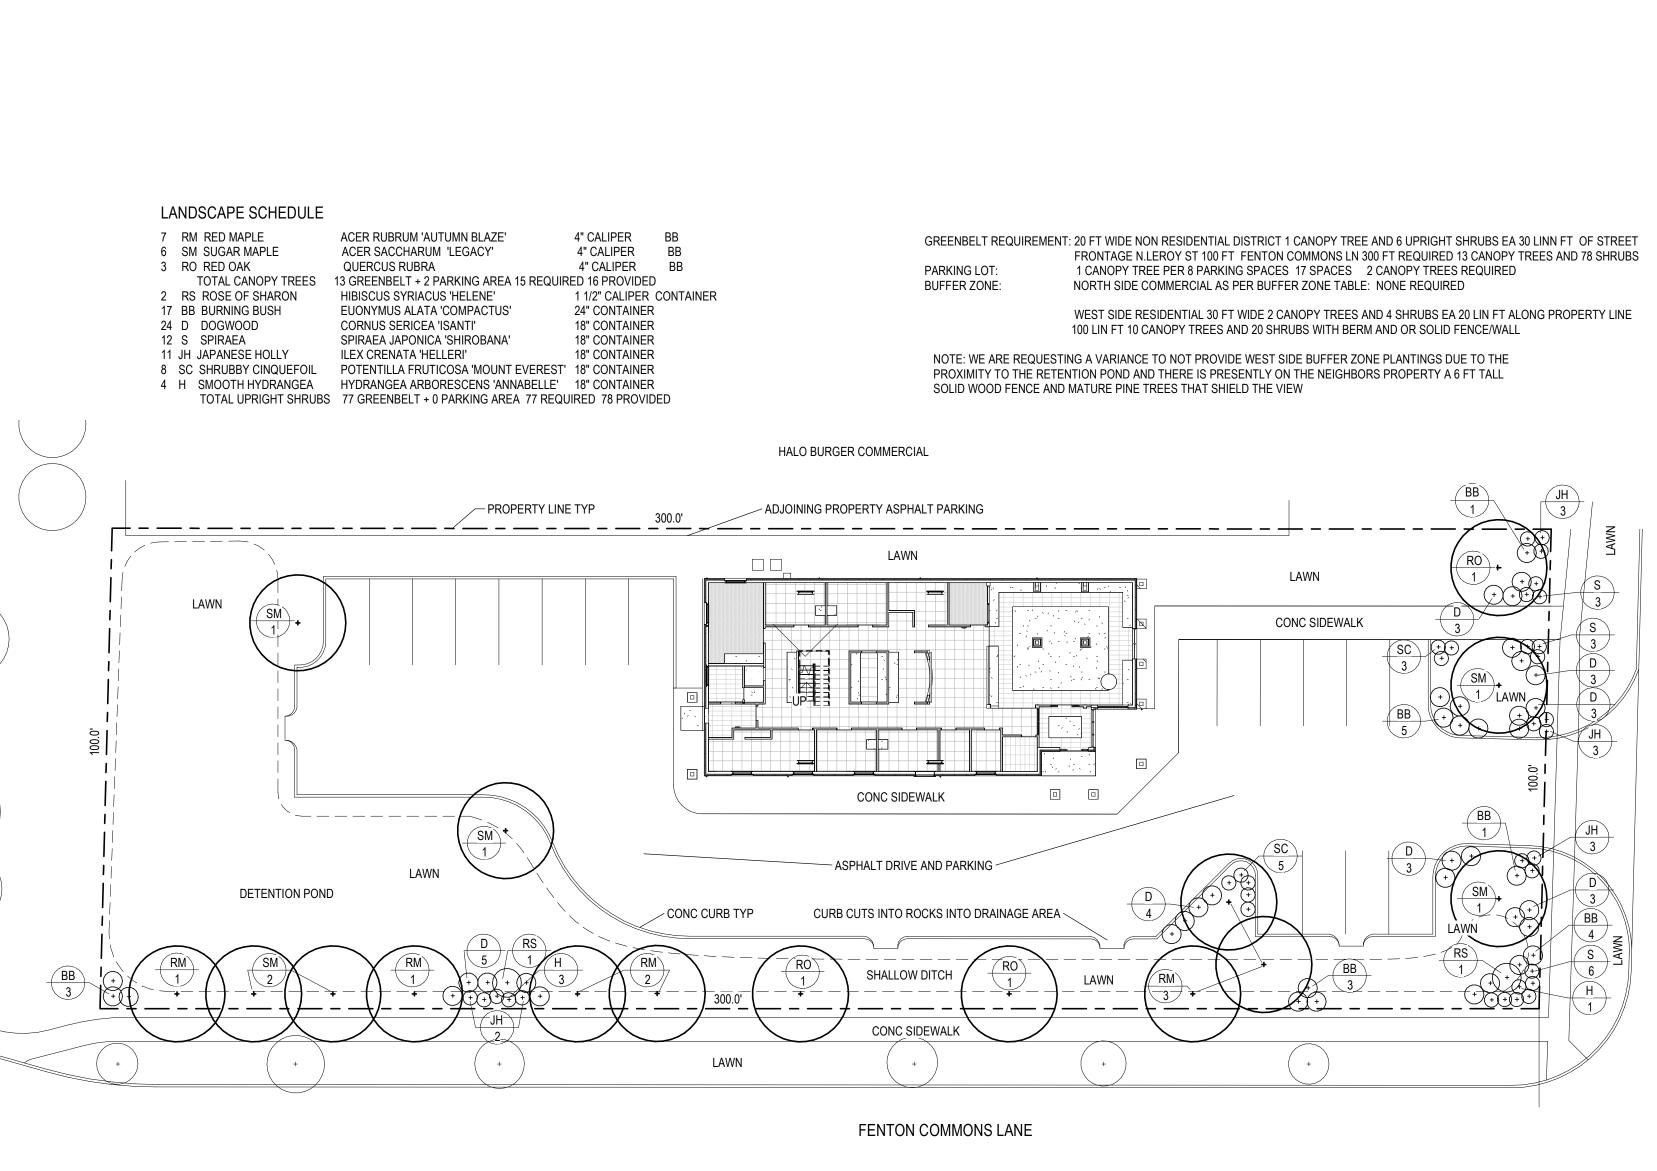

M.D.O.T. 6A WASHED NATURAL STONE

FABRIC WEED BARRIER.

- PREVENT SOIL FROM

COLLECTING ON TOP

OF FABRIC -----

- TYPICAL –

PLACE TOP SOIL IN

BUILDING

SEE PLAN

OR CURBING

PLANTING PITS ONLY

1/4"/FT. ×

VARIES - SEE PLAN

4

EDGING, WALK

OR CURBING,

SEE PLAN

 \rightarrow



3 Landscape Notes

THIN FOLIAGE & BRANCHES (NOT ALL END TIPS)

SHRUB SHALL BEAR SAME RELATION TO FINISH

GRADE AS IT BORE TO PREVIOUS EXISTING GRADE.

- REMOVE CONTAINER OR

1/3 OF WRAPPING AT

PLANTING SOIL MIX -

3:1 RATIO BY VOLUME

TOPSOIL & PEAT MOSS AT

TOP OF BALL

BY 1/3 - RETAIN NATURAL SHAPE

4" STONE

3" SAUCER

COMPACTED

SUBSOIL (SCARIFY

TO 4" DEEP) -

<u>GRADING</u> - PREMISES ARE AS FOUND. REMOVE ALL BRUSH, TREES, AND/OR VEGETATION THAT MAY INTERFERE WITH BUILDING AND CONSTRUCTION IMPROVEMENTS. STRIP AND STOCKPILE TOP SOIL TO BE REUSED FOR FINAL GRADING. PROVIDE ADDITIONAL TOP SOIL IF NECESSARY. REMOVE EXCESS SPOIL MATERIALS AND TOP SOIL FROM SITE. GRADE TO LINES AND LEVELS SHOWN.

LANDSCAPE - INSTALL TREES, SHRUBS, SIZES AS SHOWN. DO NOT PLANT UNTIL FINAL GRADES ARE ESTABLISHED AND LAWNS ARE SEEDED. IN AREAS OF SHRUBS, PROVIDE A PRE-EMERGENT WEED KILLER SUCH AS BANLON. UTILIZE LANDSCAPE CLOTH UNDER MULCH, OVER SUBGRADE. PLANT AS PER NURSERY STANDARDS. FERTILIZE. ALL TREES AND SHRUBS, PLANT WITH 6" SHREDDED BARK MULCH.

LAWN SEED FORMULATION, 40% KENTUCKY BLUE, 40% CREEPING RED, AND 20% FIESTA FINE LEAF RYE. SEEDING MAY BE DONE WITH STRAW MULCH OR HYDROSEEDING.


ALL SHRUBS, TREES, AND OTHER PLANTS CONFORMING TO ANSI Z60.1 RECOMMENDATIONS. GUARANTEE ALL SHRUBS AND TREES AND PLANTS FOR ON (1) YEAR. LAWN ACCEPTANCE WILL BE AFTER SECOND MOWING.



1 Landscape Plan

NOTE: THIS SHEET IS ONLY FOR USE BY THE LANDSCAPE CONTRACTOR, SEE CIVIL ENGINEERS DRAWINGS FOR FULL SITE DESIGN INFORMATION



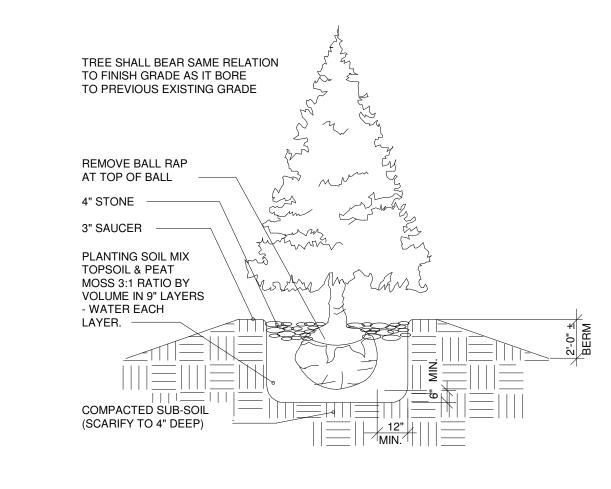



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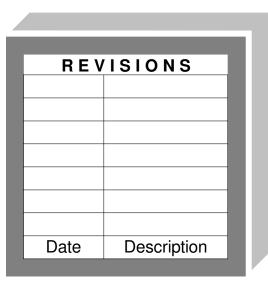
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EDGEWICK

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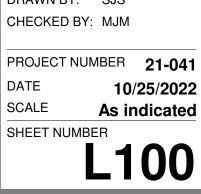








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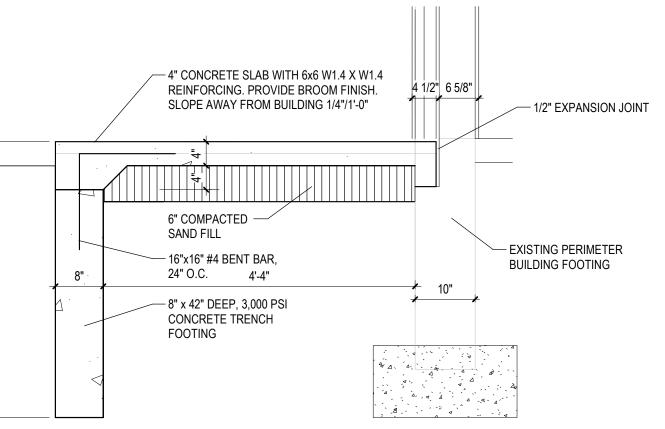
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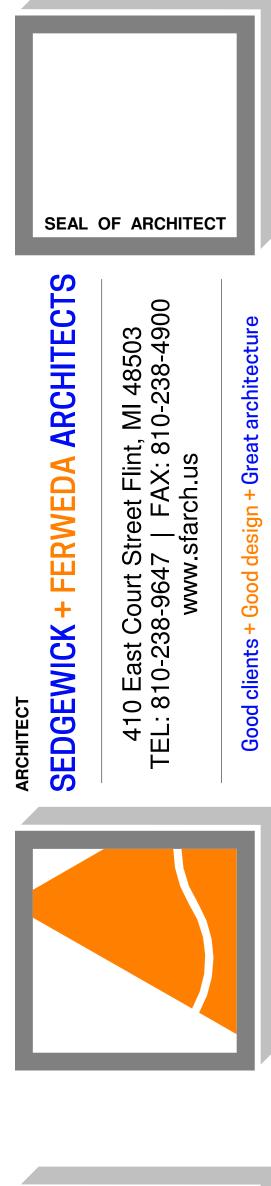





2 Exterior Details - Proposed Concrete Stoop Section Detail

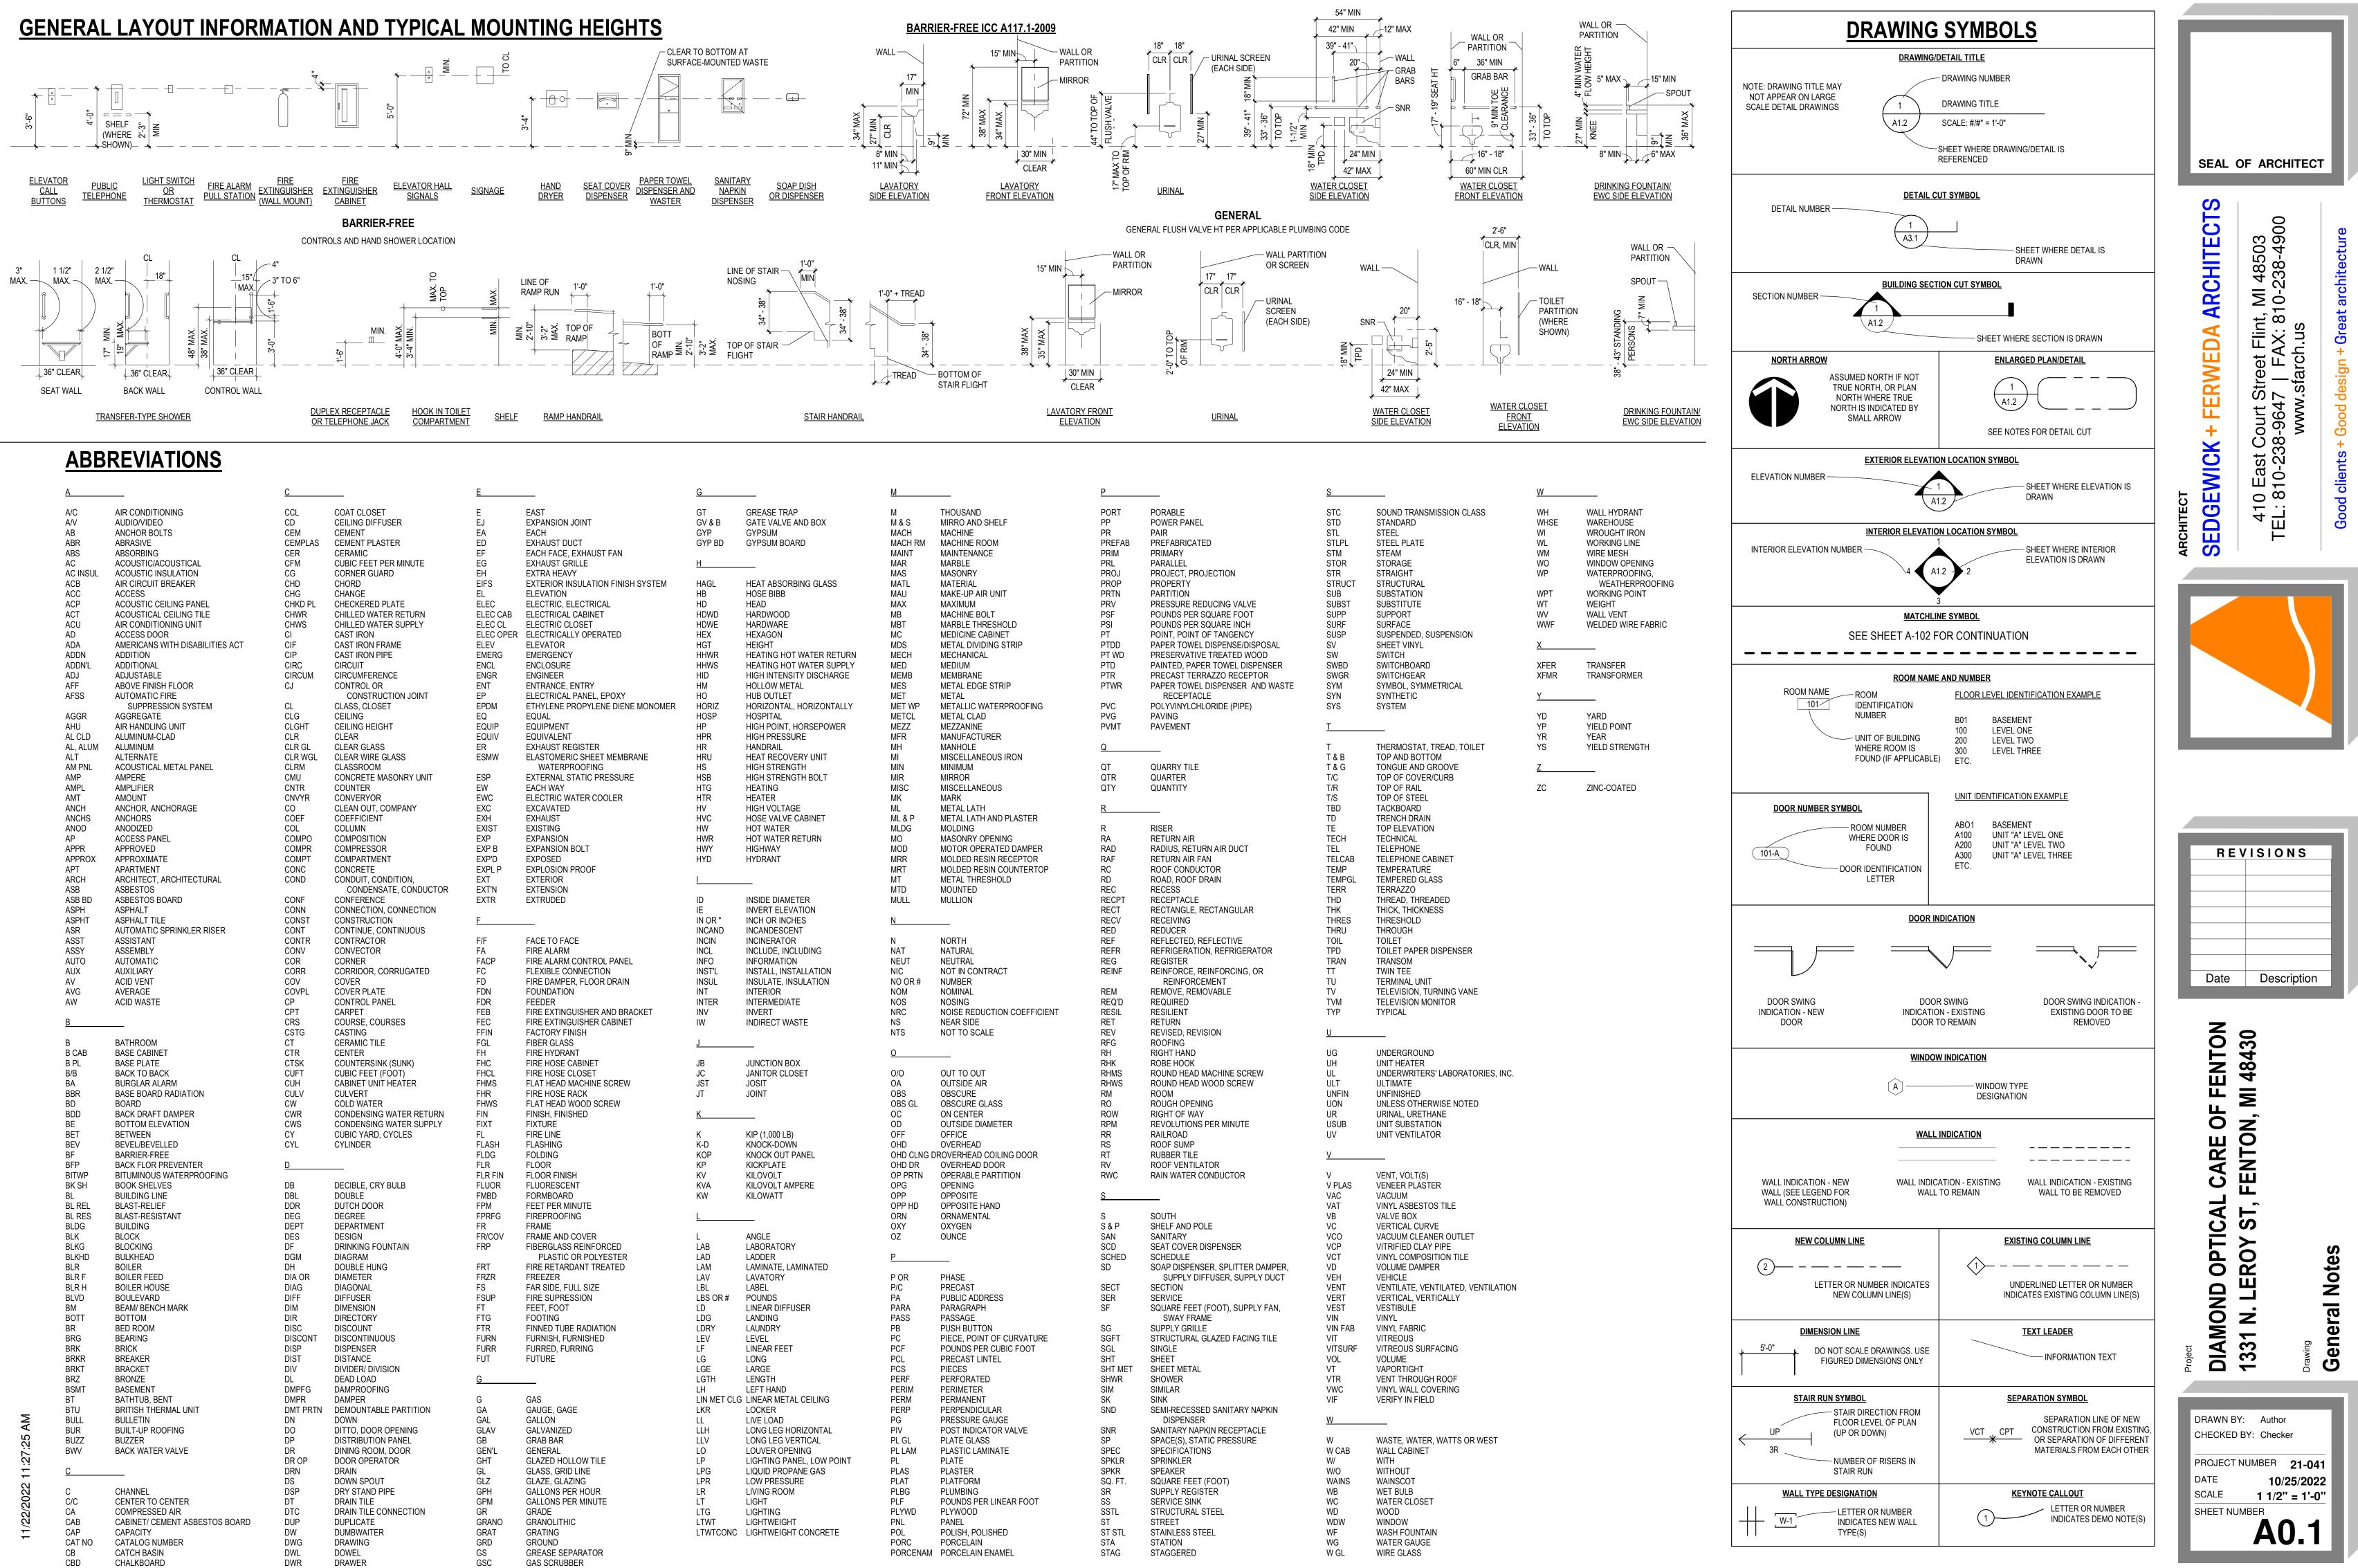 1
 Foundation Plan

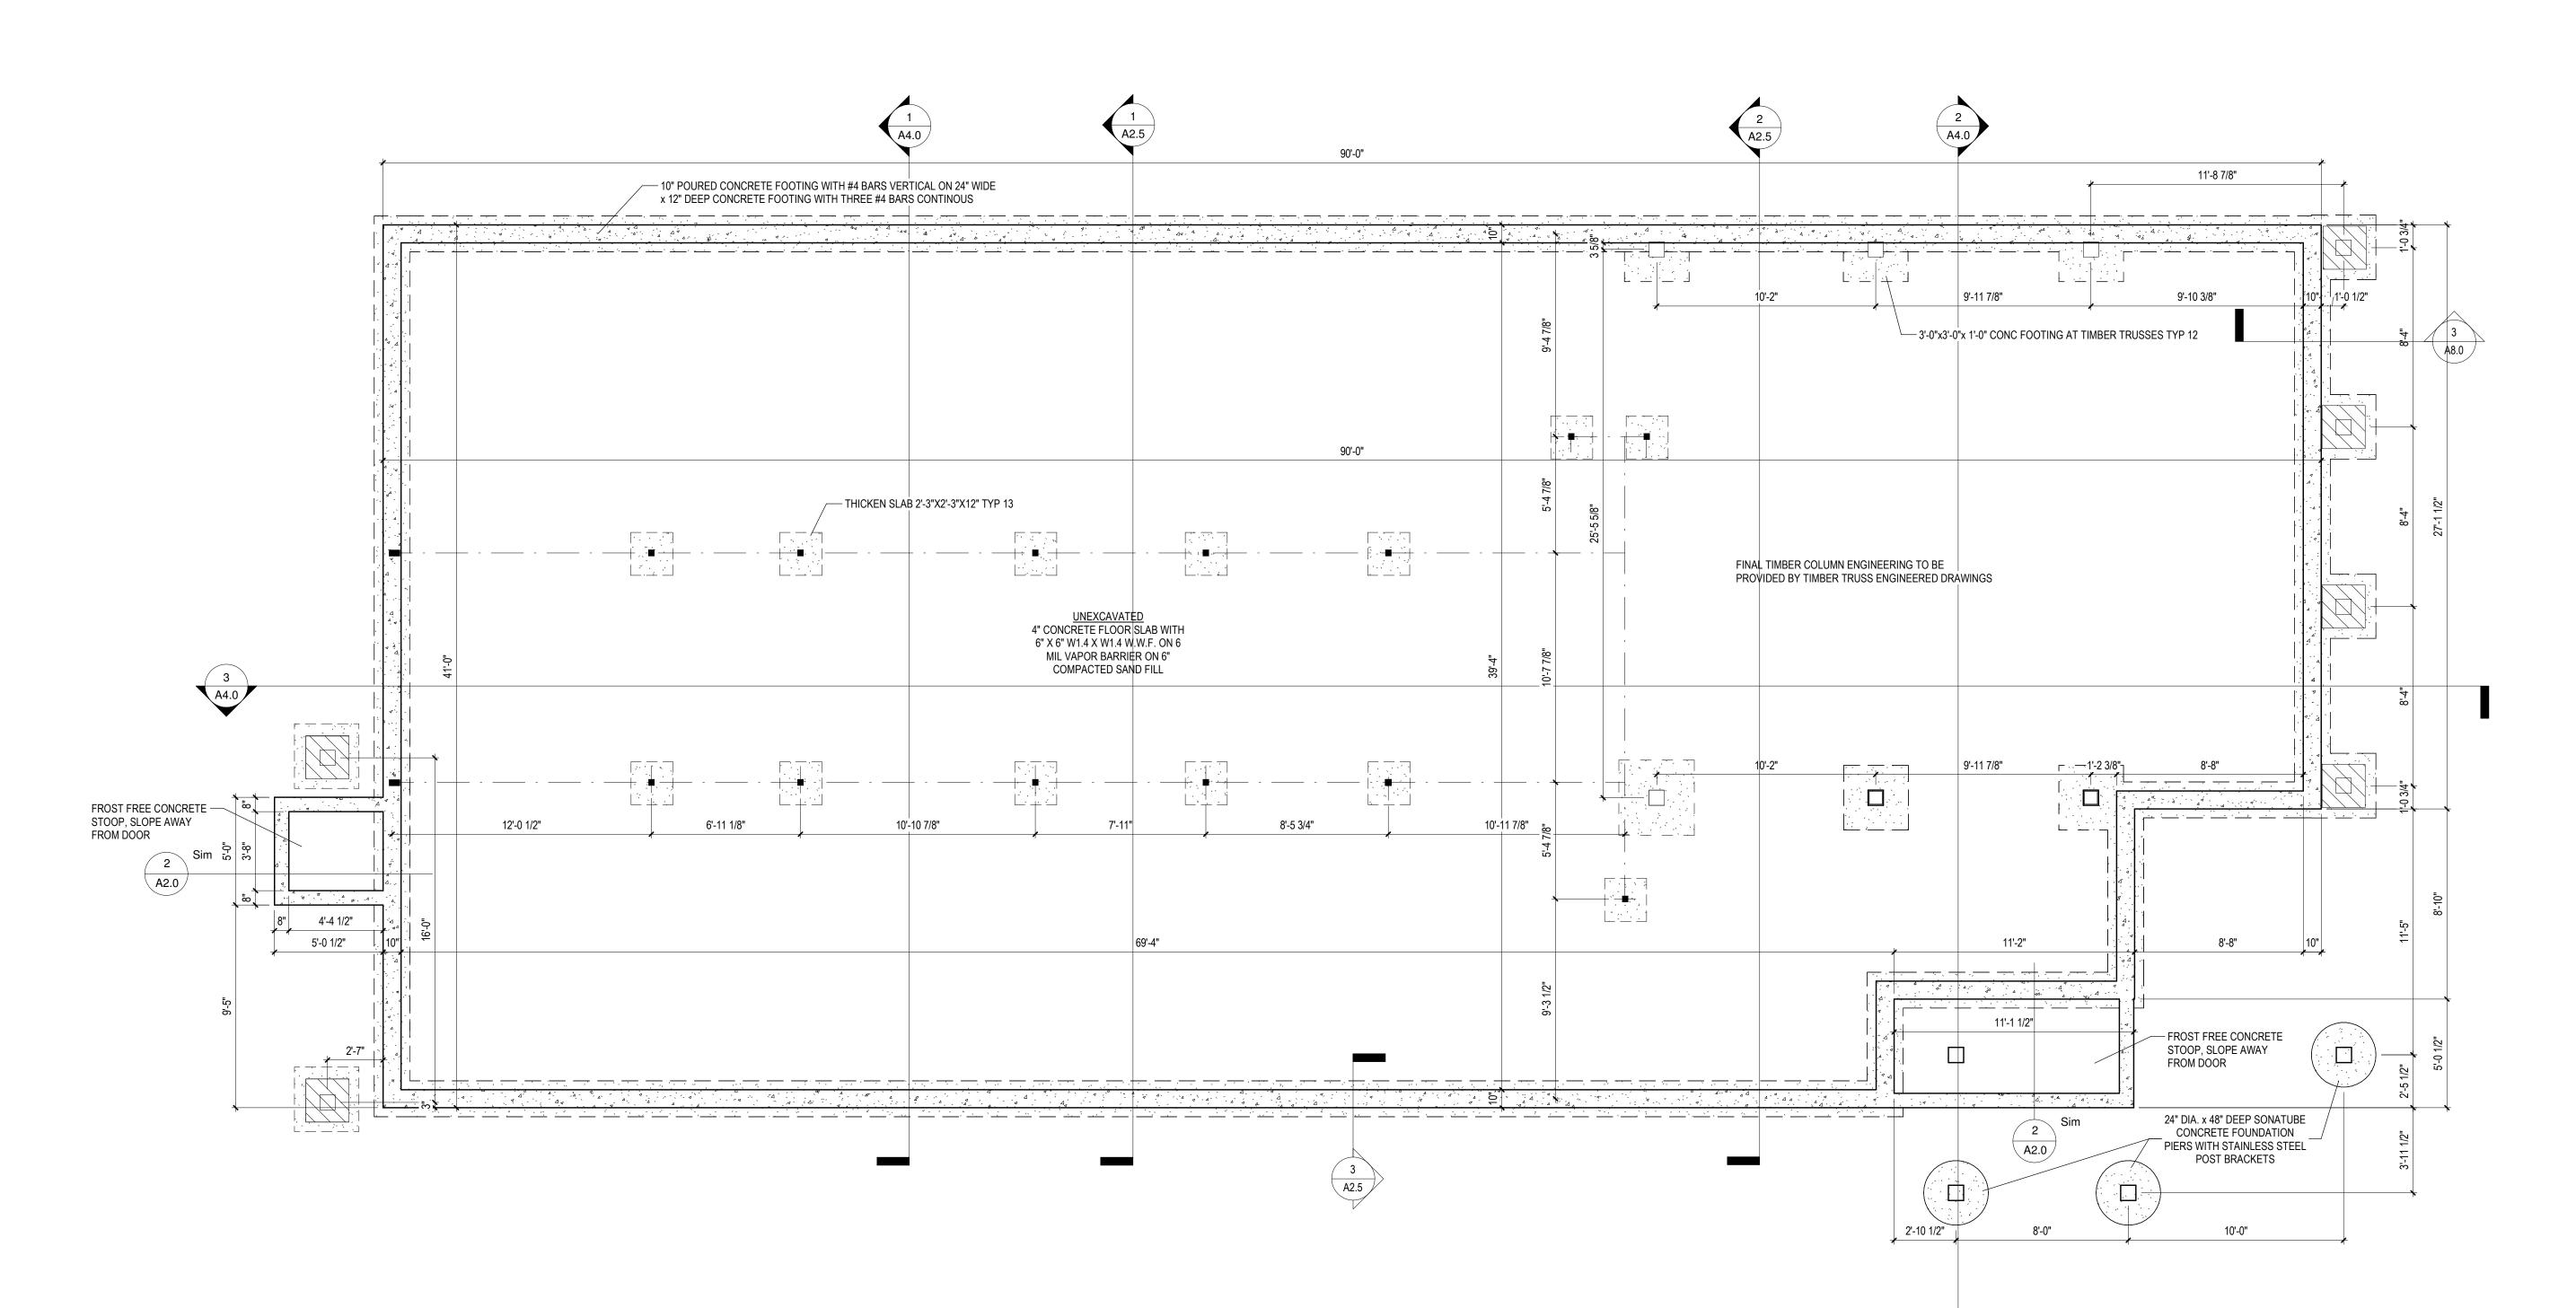 A2.0
 1/4" = 1'-0"



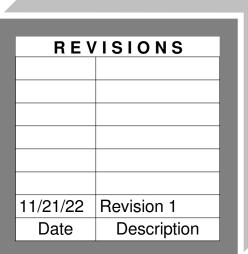


DIAMOND OPTICAL CARE OF FENTON 1331 N. LEROY ST, FENTON, MI 48430 DRAWN BY: LJK

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Found


CHECKED BY: SJS PROJECT NUMBER 21-041 DATE 10/25/2022 SCALE As indicated SHEET NUMBER A2.0

WINDOW SCHEDULE									
TYPE	R	.0.	HEAD						
MARK	WIDTH	HEIGHT	HEIGHT	COMMENTS					
Α	4'-0"	5'-0"	<varies></varies>						
В	3'-0"	4'-0"	7'-4"						
С	4'-0" 3'-0" 7'-0" INTERIOR WINDOW								
13									

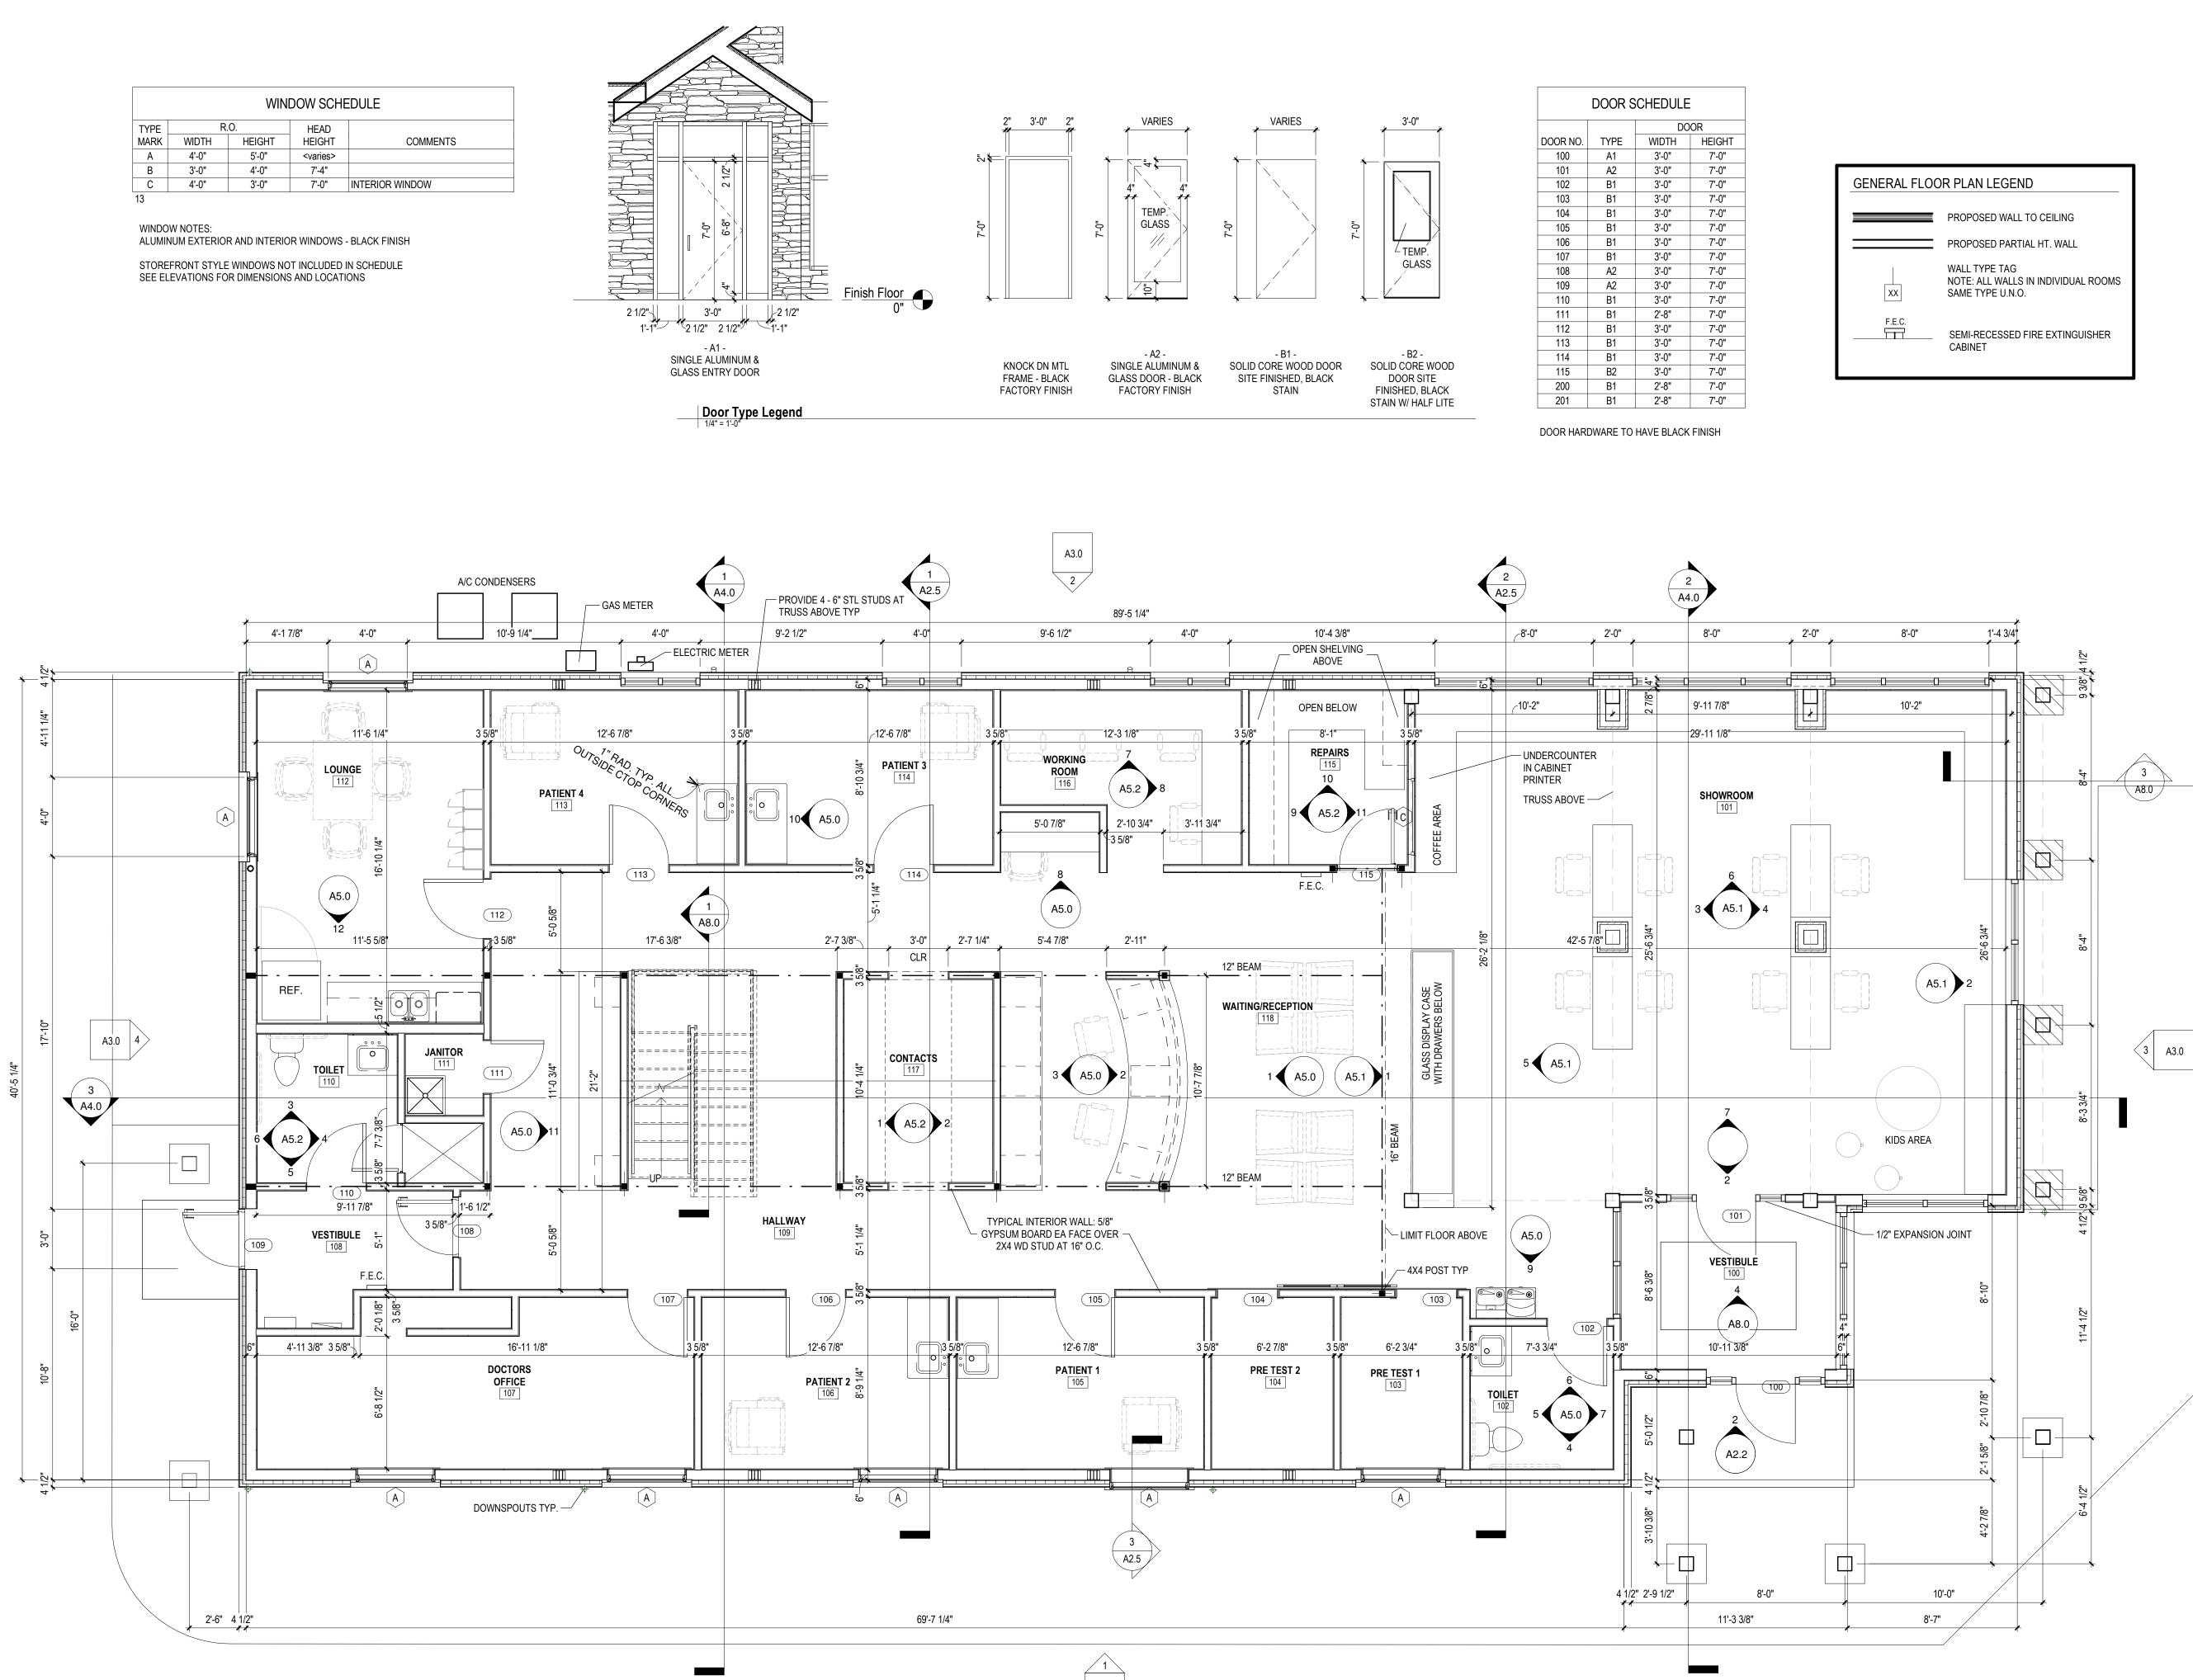

A3.0

1 First Floor Plan A2.1 1/4" = 1'-0"

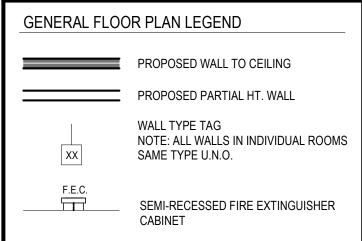

REVISIONS

SEAL OF ARCHITECT

410 East Court Street Flint, MI 48503 EL: 810-238-9647 | FAX: 810-238-4900 www.sfarch.us

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SEDGEWICK + FERWEDA ARCHITECTS


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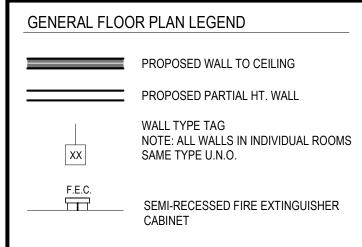
11/21/22 Revision 1


Date Description

WINDOW SCHEDULE								
TYPE		0.	HEAD					
MARK	WIDTH	HEIGHT	HEIGHT	COMMENTS				
А	4'-0"	5'-0"	<varies></varies>					
В	3'-0"	4'-0"	7'-4"					
С	4'-0"	3'-0"	7'-0"	INTERIOR WINDOW				
13								



	DO	OR
TYPE	WIDTH	HEIGHT
A1	3'-0"	7'-0"
A2	3'-0"	7'-0"
B1	3'-0"	7'-0"
A2	3'-0"	7'-0"
A2	3'-0"	7'-0"
B1	3'-0"	7'-0"
B1	2'-8"	7'-0"
B1	3'-0"	7'-0"
B1	3'-0"	7'-0"
B1	3'-0"	7'-0"
B2	3'-0"	7'-0"
B1	2'-8"	7'-0"
B1	2'-8"	7'-0"

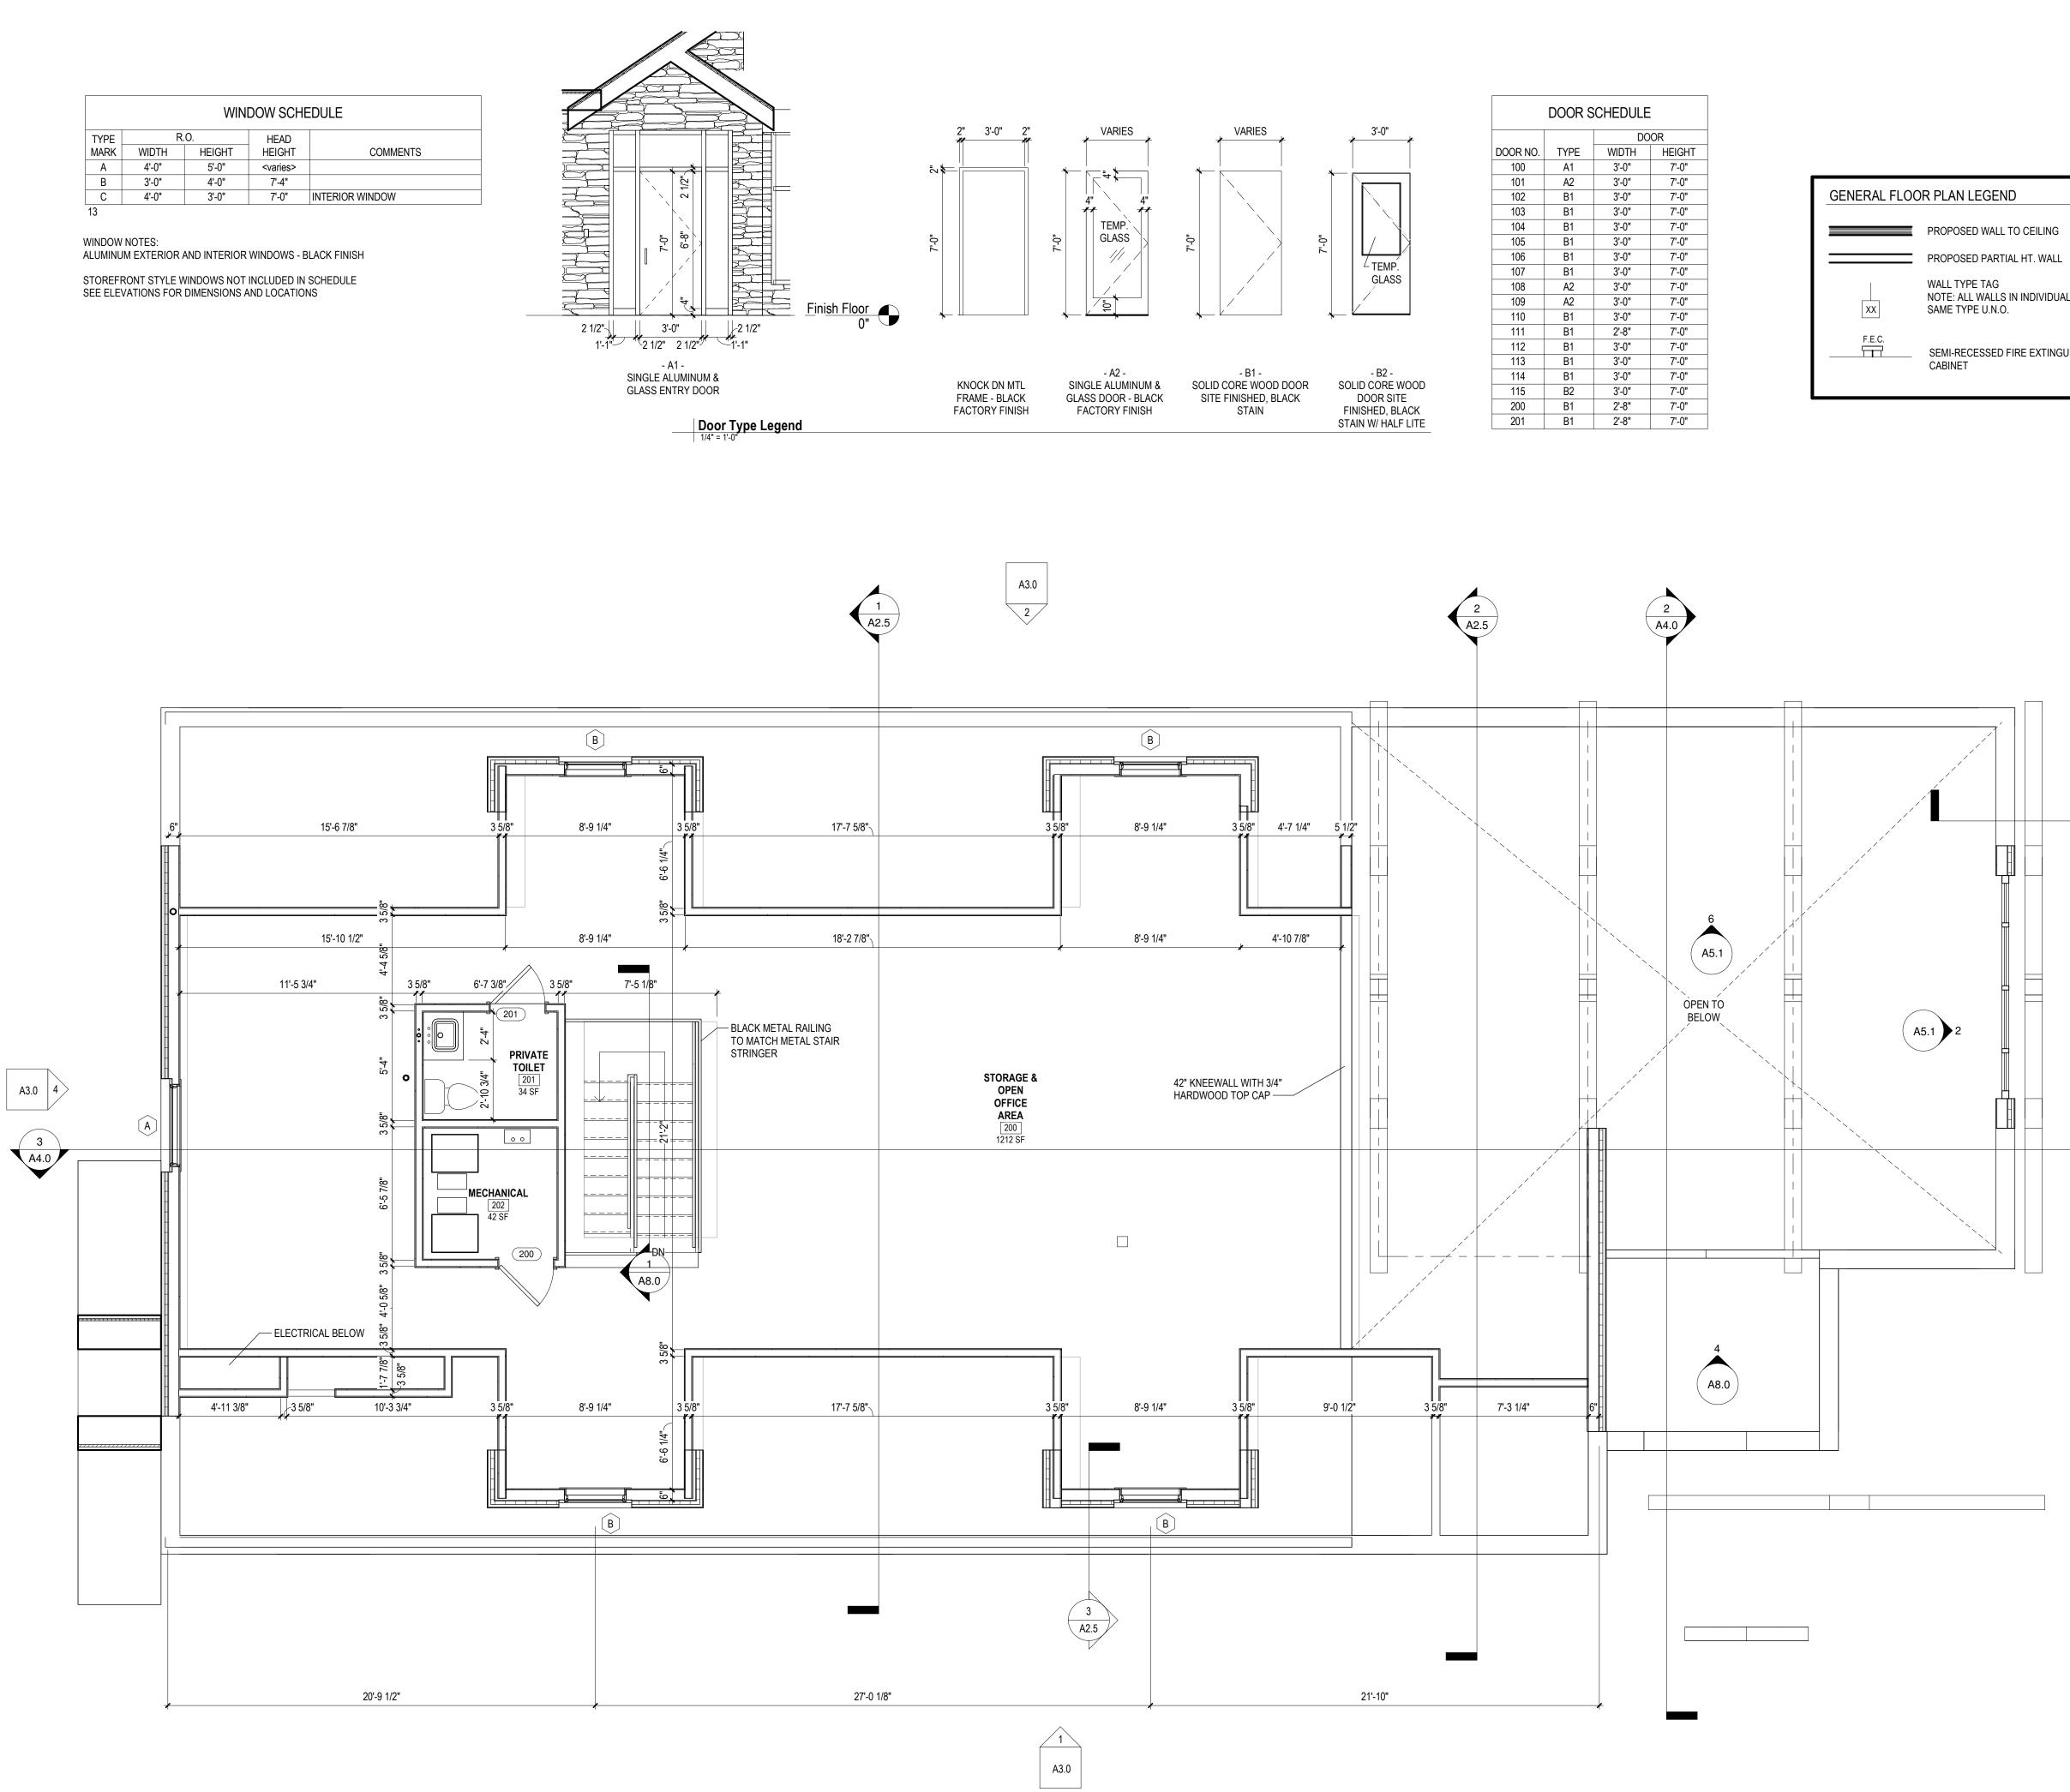

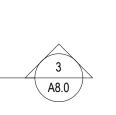



SEAL OF ARCHITECT


410 East Court Street Flint, MI 48503 EL: 810-238-9647 | FAX: 810-238-4900 www.sfarch.us

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SEDGEWICK + FERWEDA ARCHITECTS

CHITECT



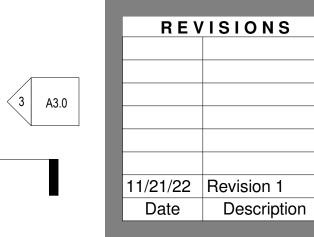


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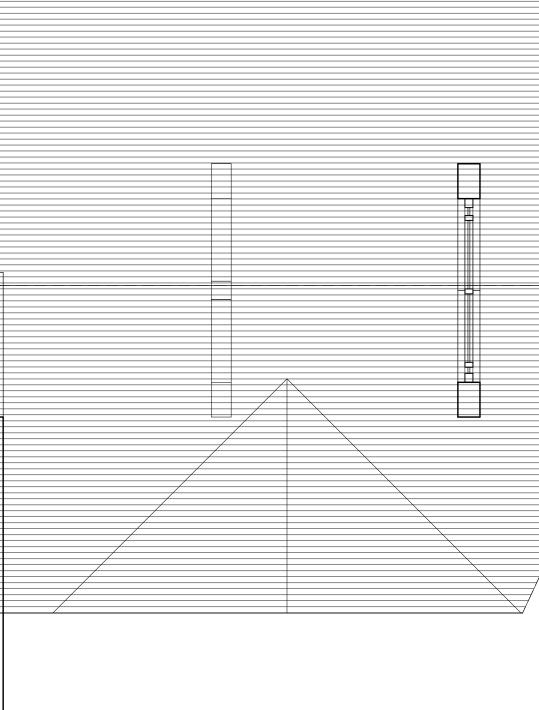
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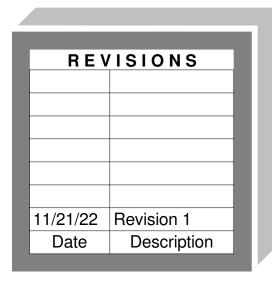
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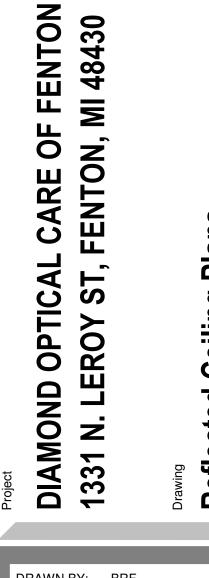






ARCHITECT SEDGEWICK + FERWEDA ARCHITECTS 410 East Court Street Flint, MI 48503 TEL: 810-238-9647 | FAX: 810-238-4900 www.sfarch.us Good

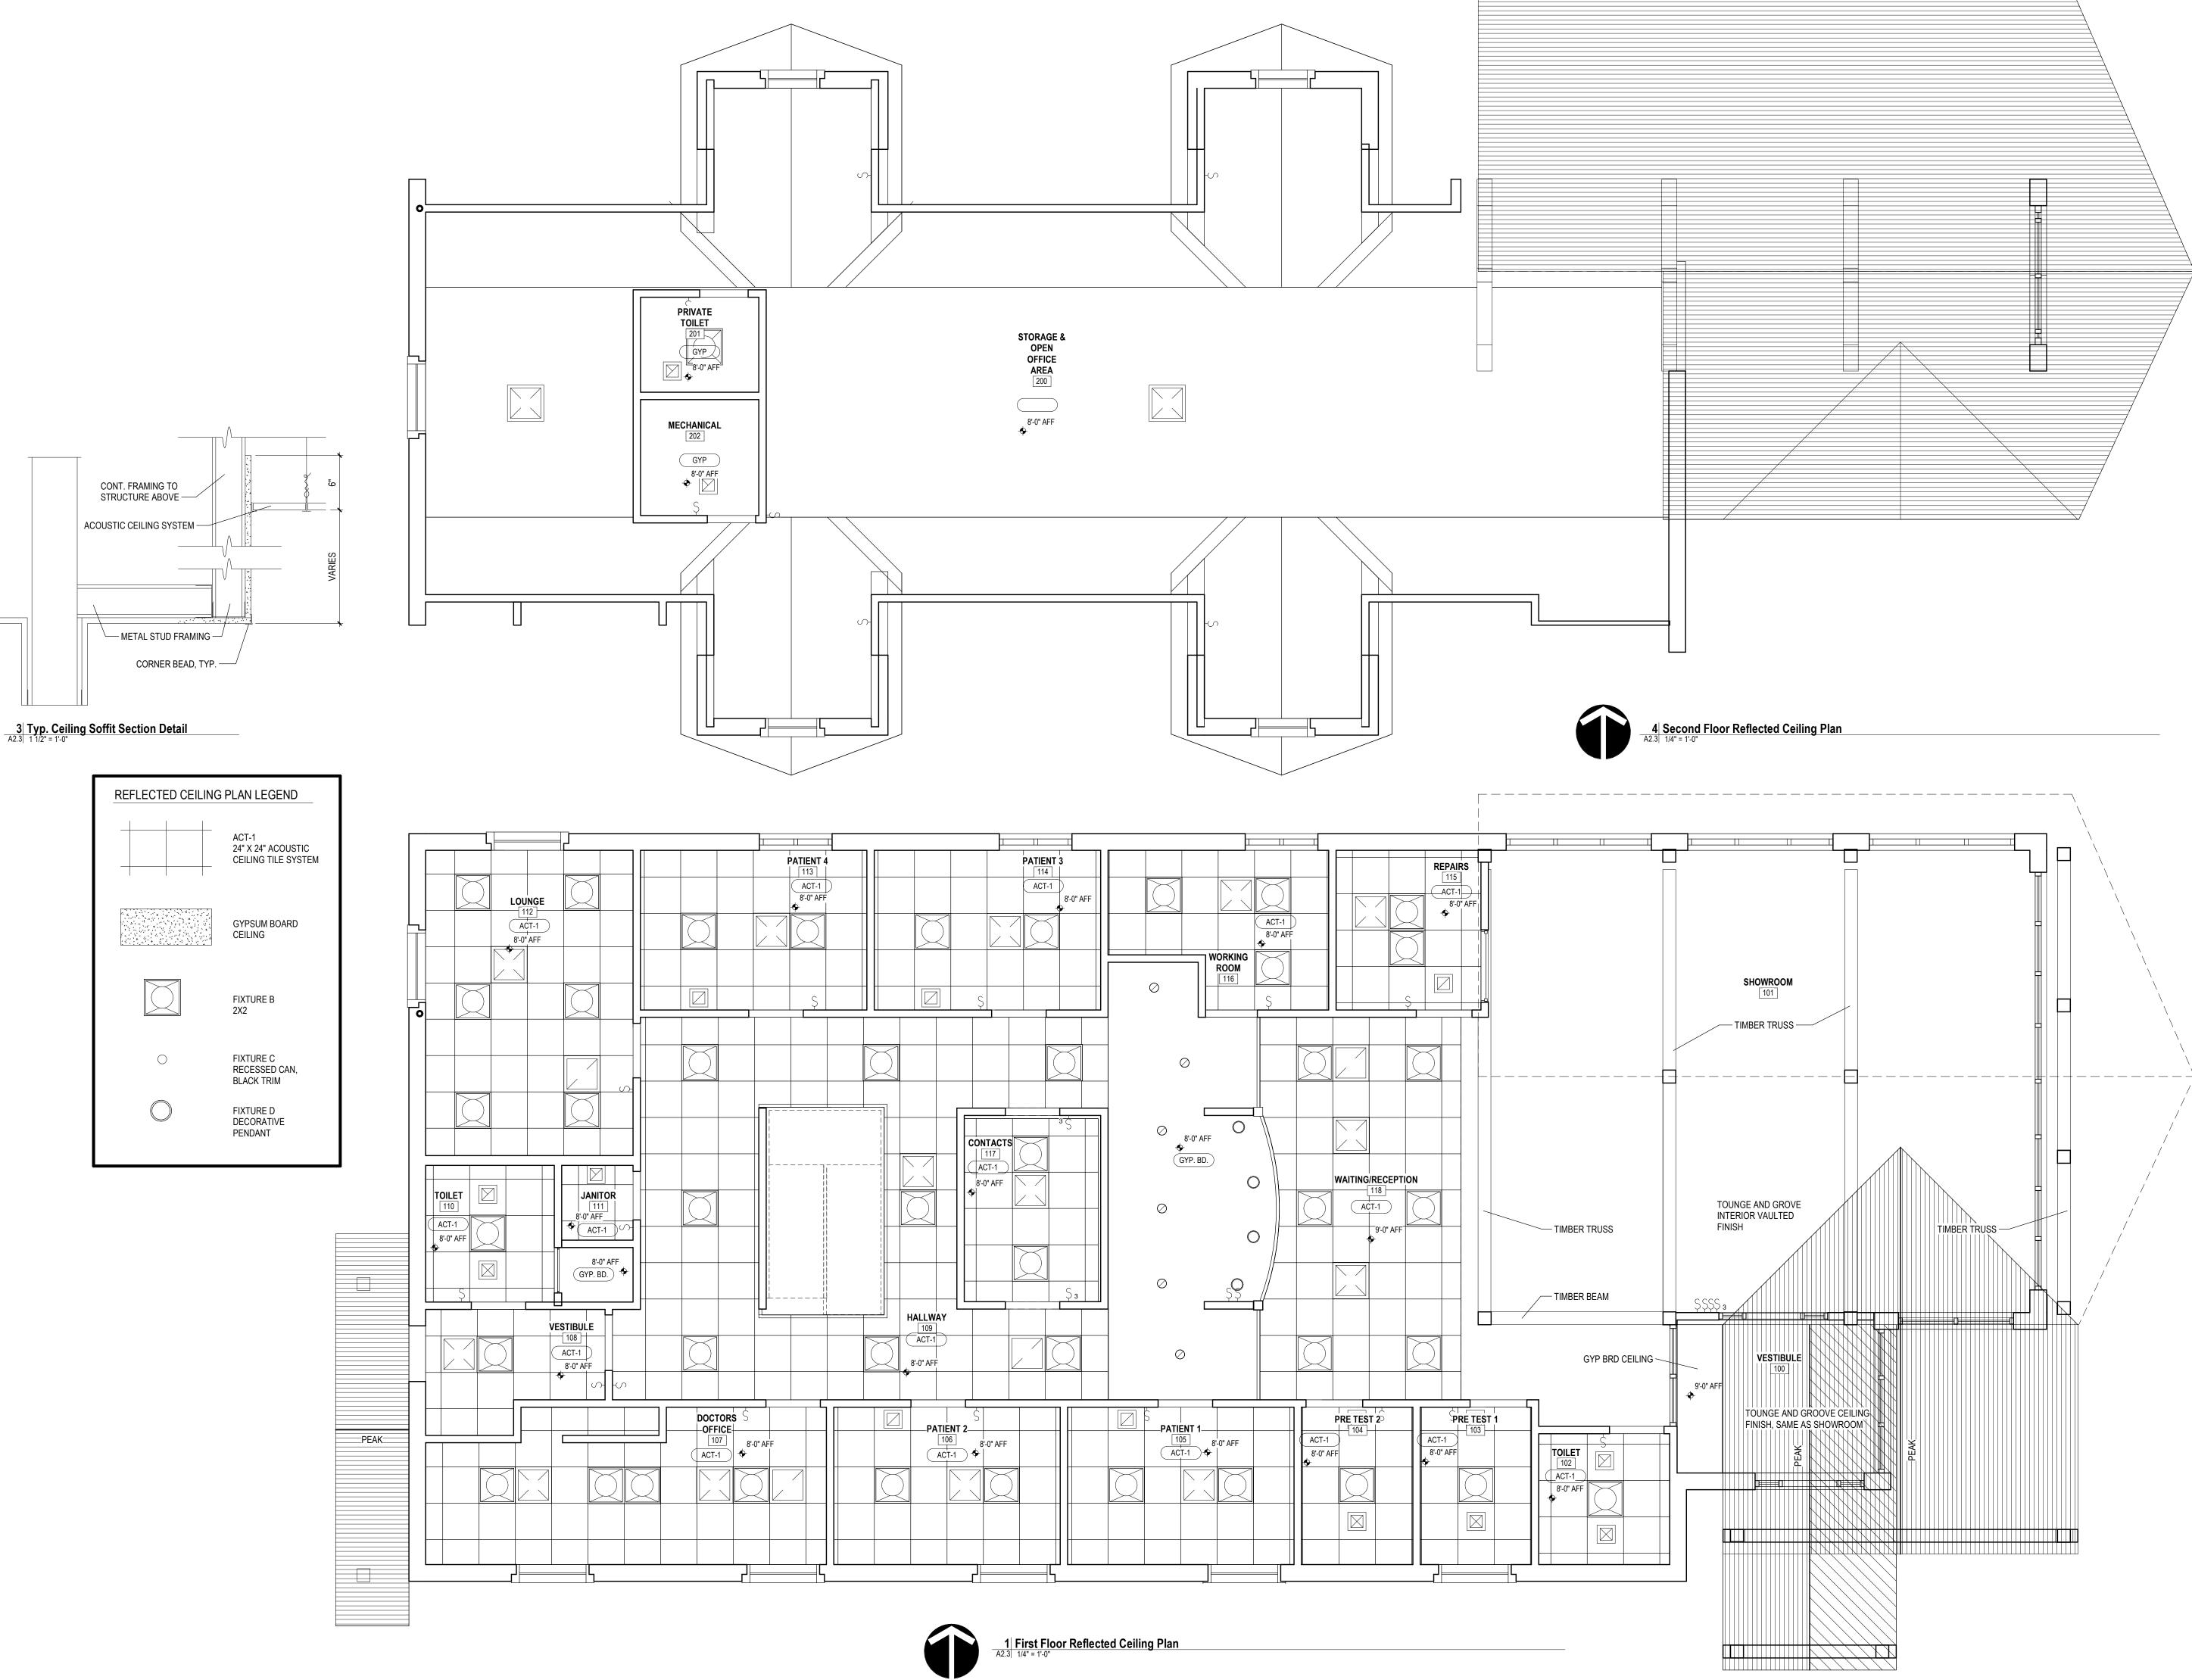





Ceiling Plans Reflected

DRAWN BY: BRF CHECKED BY: BRF DATE

PROJECT NUMBER 21-041 10/25/2022 SCALE As indicated SHEET NUMBER A2.3




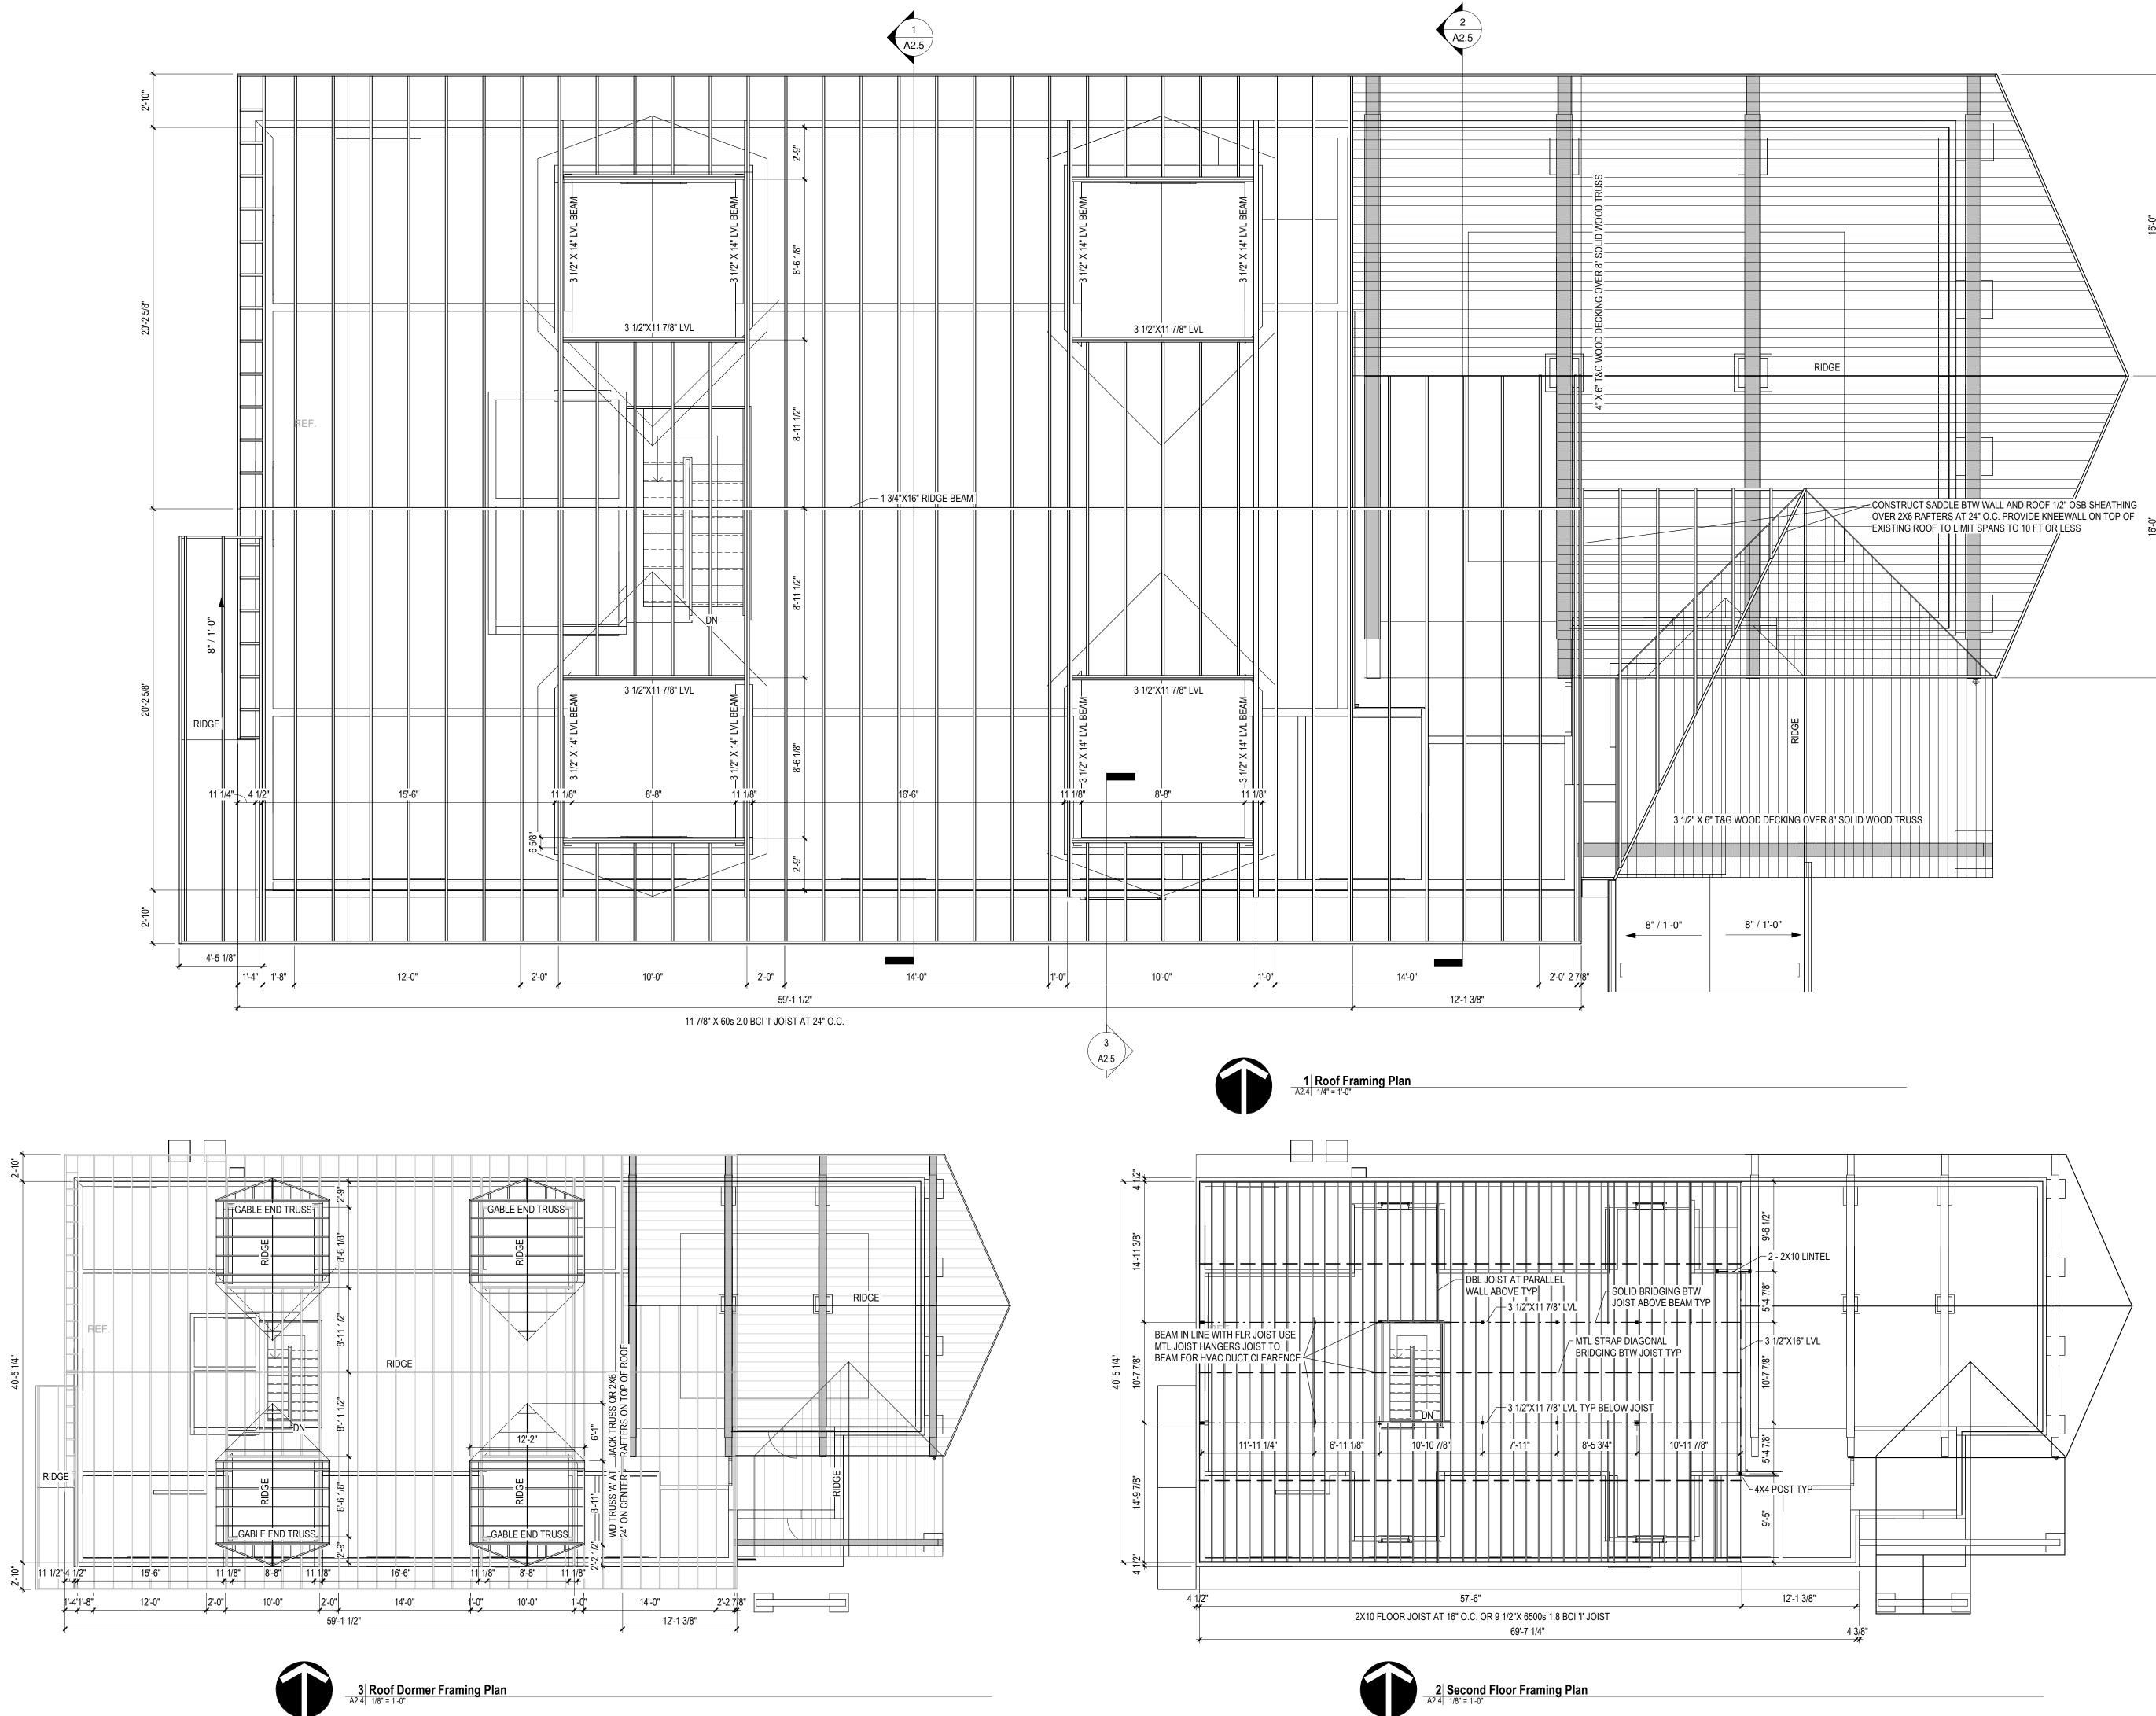


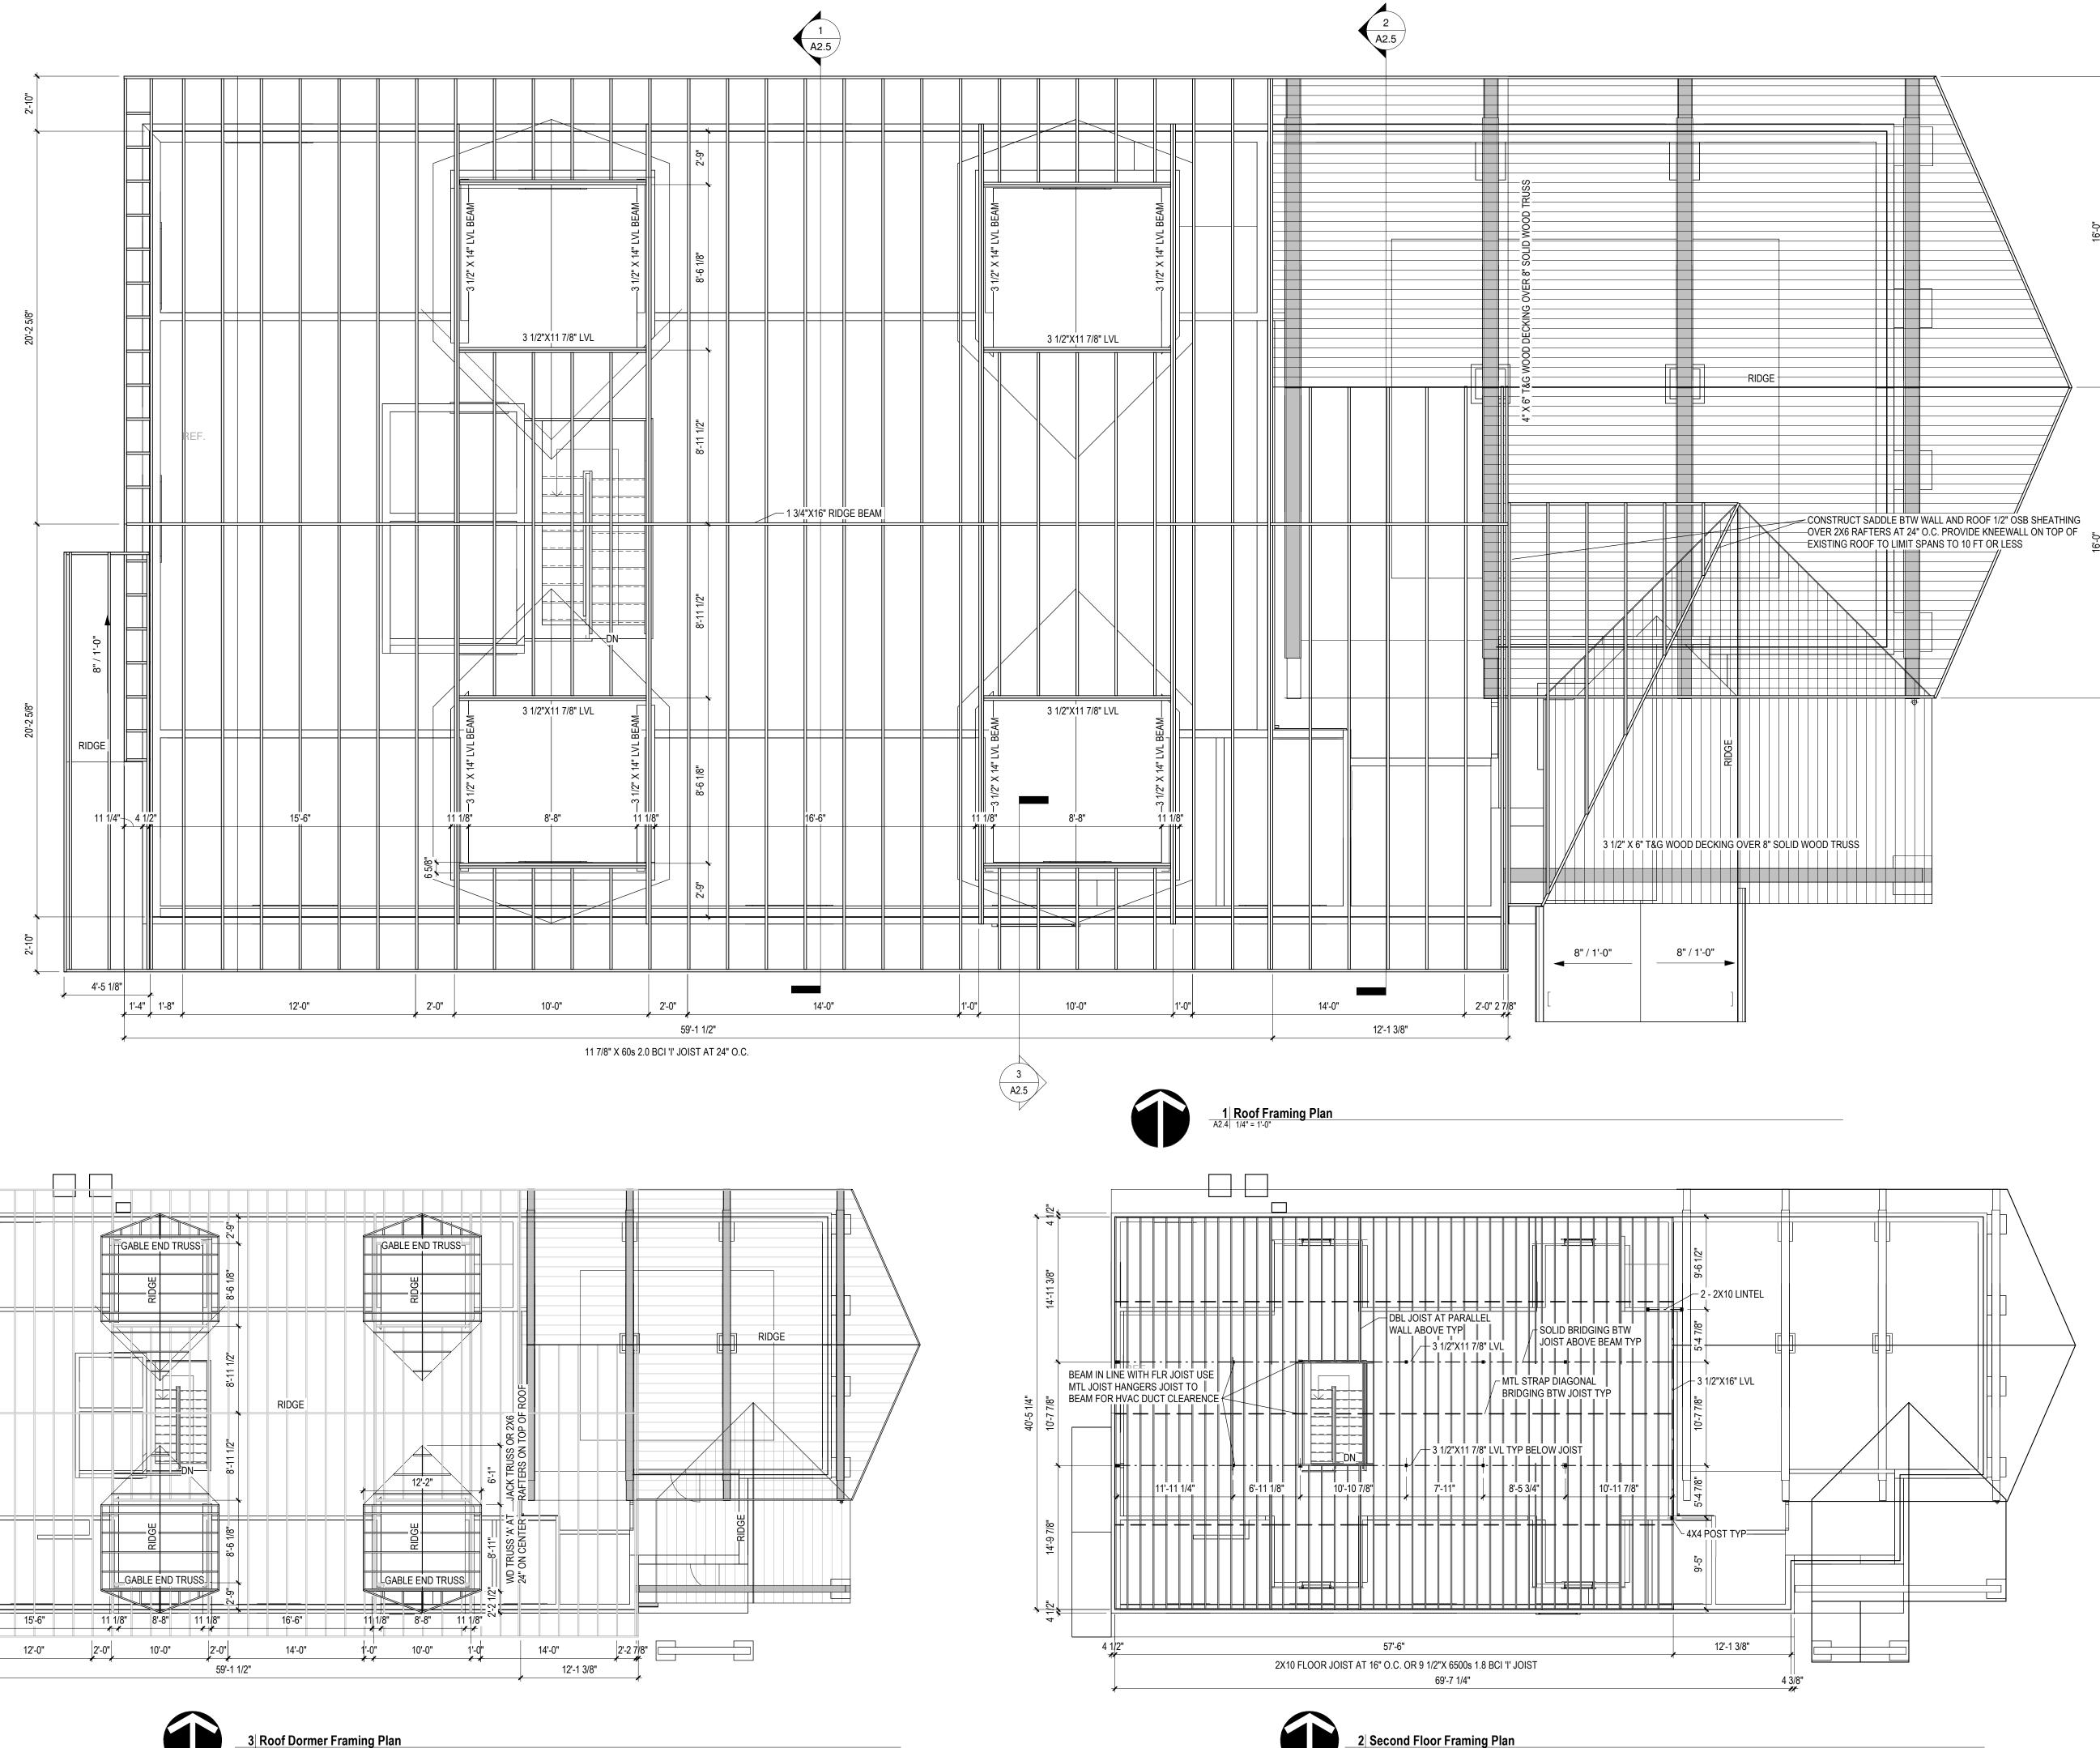






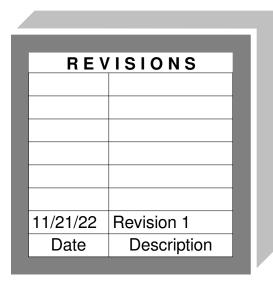

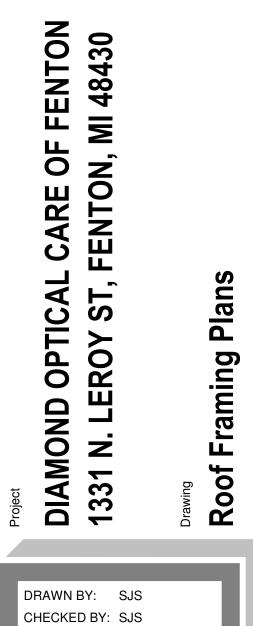

PROJECT NUMBER 21-041 DATE 10/25/2022 SCALE As indicated SHEET NUMBER **A2.4**

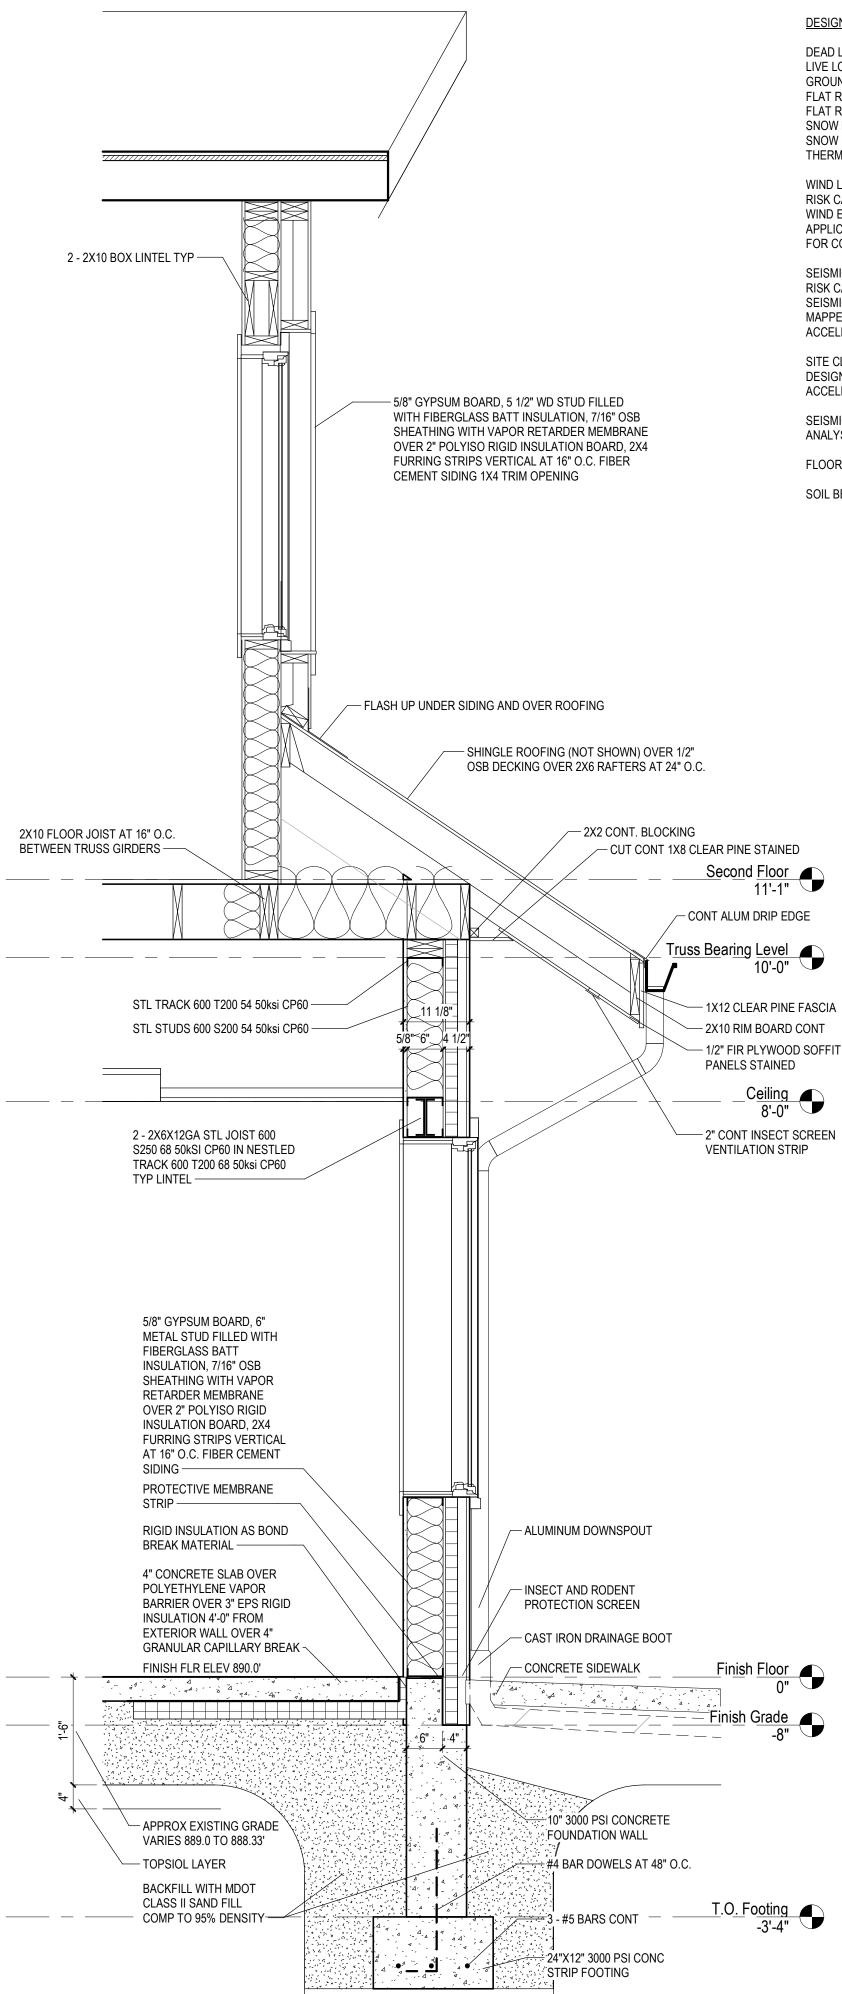

DESIGN LOADS:

DEAD LOAD 15 LBS/SQ FT LIVE LOAD 20 LBS/SQ FT NON-REDUCIBLE GROUND SNOW LOAD (Pg) 25 LBS/SQ FT FLAT ROOF FACTOR 0.7 FLAT ROOF SNOW LOAD (Pf) 21 LBS/SQ FT SNOW LOAD IMPORTANCE FACTOR (Is) 1.1 SNOW EXPOSURE COEFFICIENT (CE) 1.0 PARTIALLY EXPOSED THERMAL COEFFICIENT (Ct) 1.0 HEATED STRUCTURE

WIND LOAD 120 MPH 3 SECOND GUST RISK CATEGORY II WIND EXPOSURE 'B' APPLICABLE INTERNAL PRESSURE COEFFICIENT +/- 0.18


FOR COMPONENTS AND CLADDING 23.5 LBS/SQ FT SEISMIC INFORMATION RISK CATEGORY II SEISMIC IMPORTANCE FACTOR (Ie) 1.25 MAPPED SPECTRAL RESPONSE

ACCELERATION PARAMETERS Ss = 13.7 S1 = 1.1 SITE CLASS 'D' DESIGN SPECTRAL RESPONSE


ACCELERATION PARAMETERS SDS = 0.147 SD1 = 0.0675 SEISMIC DESIGN CATEGORY 'A' ANALYSIS PROCEDURE USED WOOD FRAME

FLOOR LOAD OFFICE 50 LBS/SQ FT


SOIL BEARING 1500 PSF

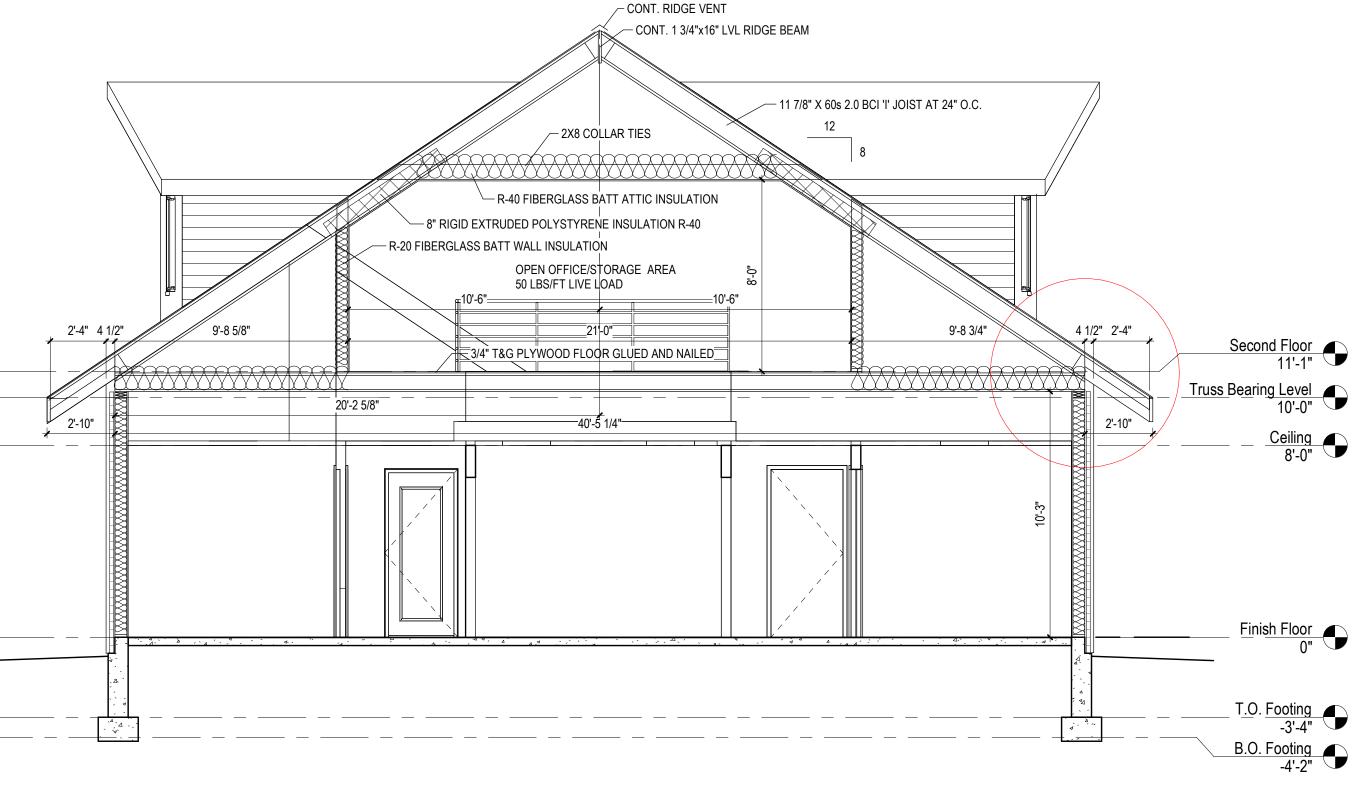

1 Bldg Framing Section 4 A2.5 1/4" = 1'-0"

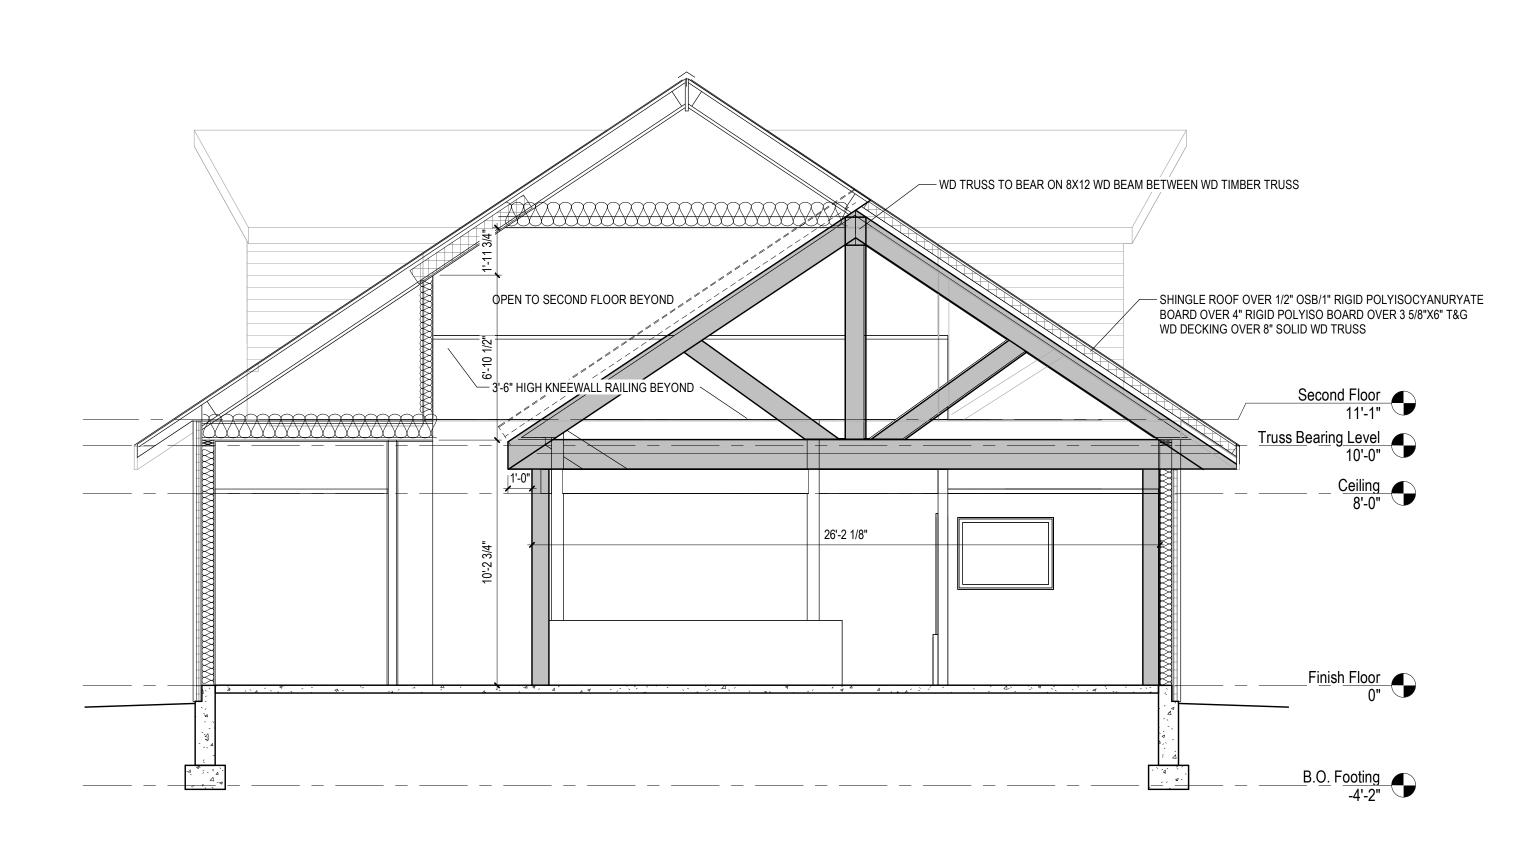

2 Bldg Framing Section 5

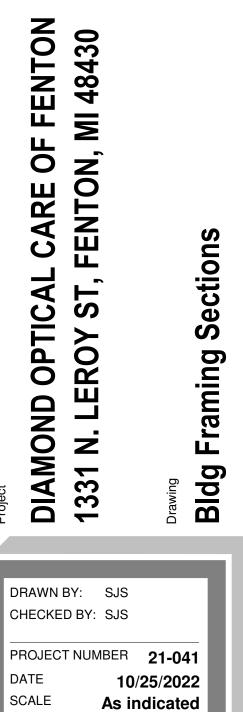

A2.5

SHEET NUMBER

REVISIONS

11/21/22 Revision 1

Date Description


ARCHITECTS : Flint, MI 48503 AX: 810-238-490 SEDGEWICK + FERWEDA Street Court 38-964 East 10-23 410 EL: 8

HITECT


SEAL OF ARCHITECT

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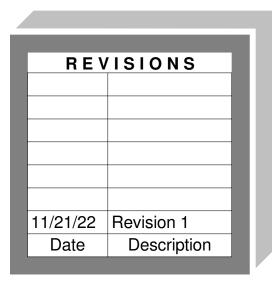



2 Dormer Roof Truss 'A'
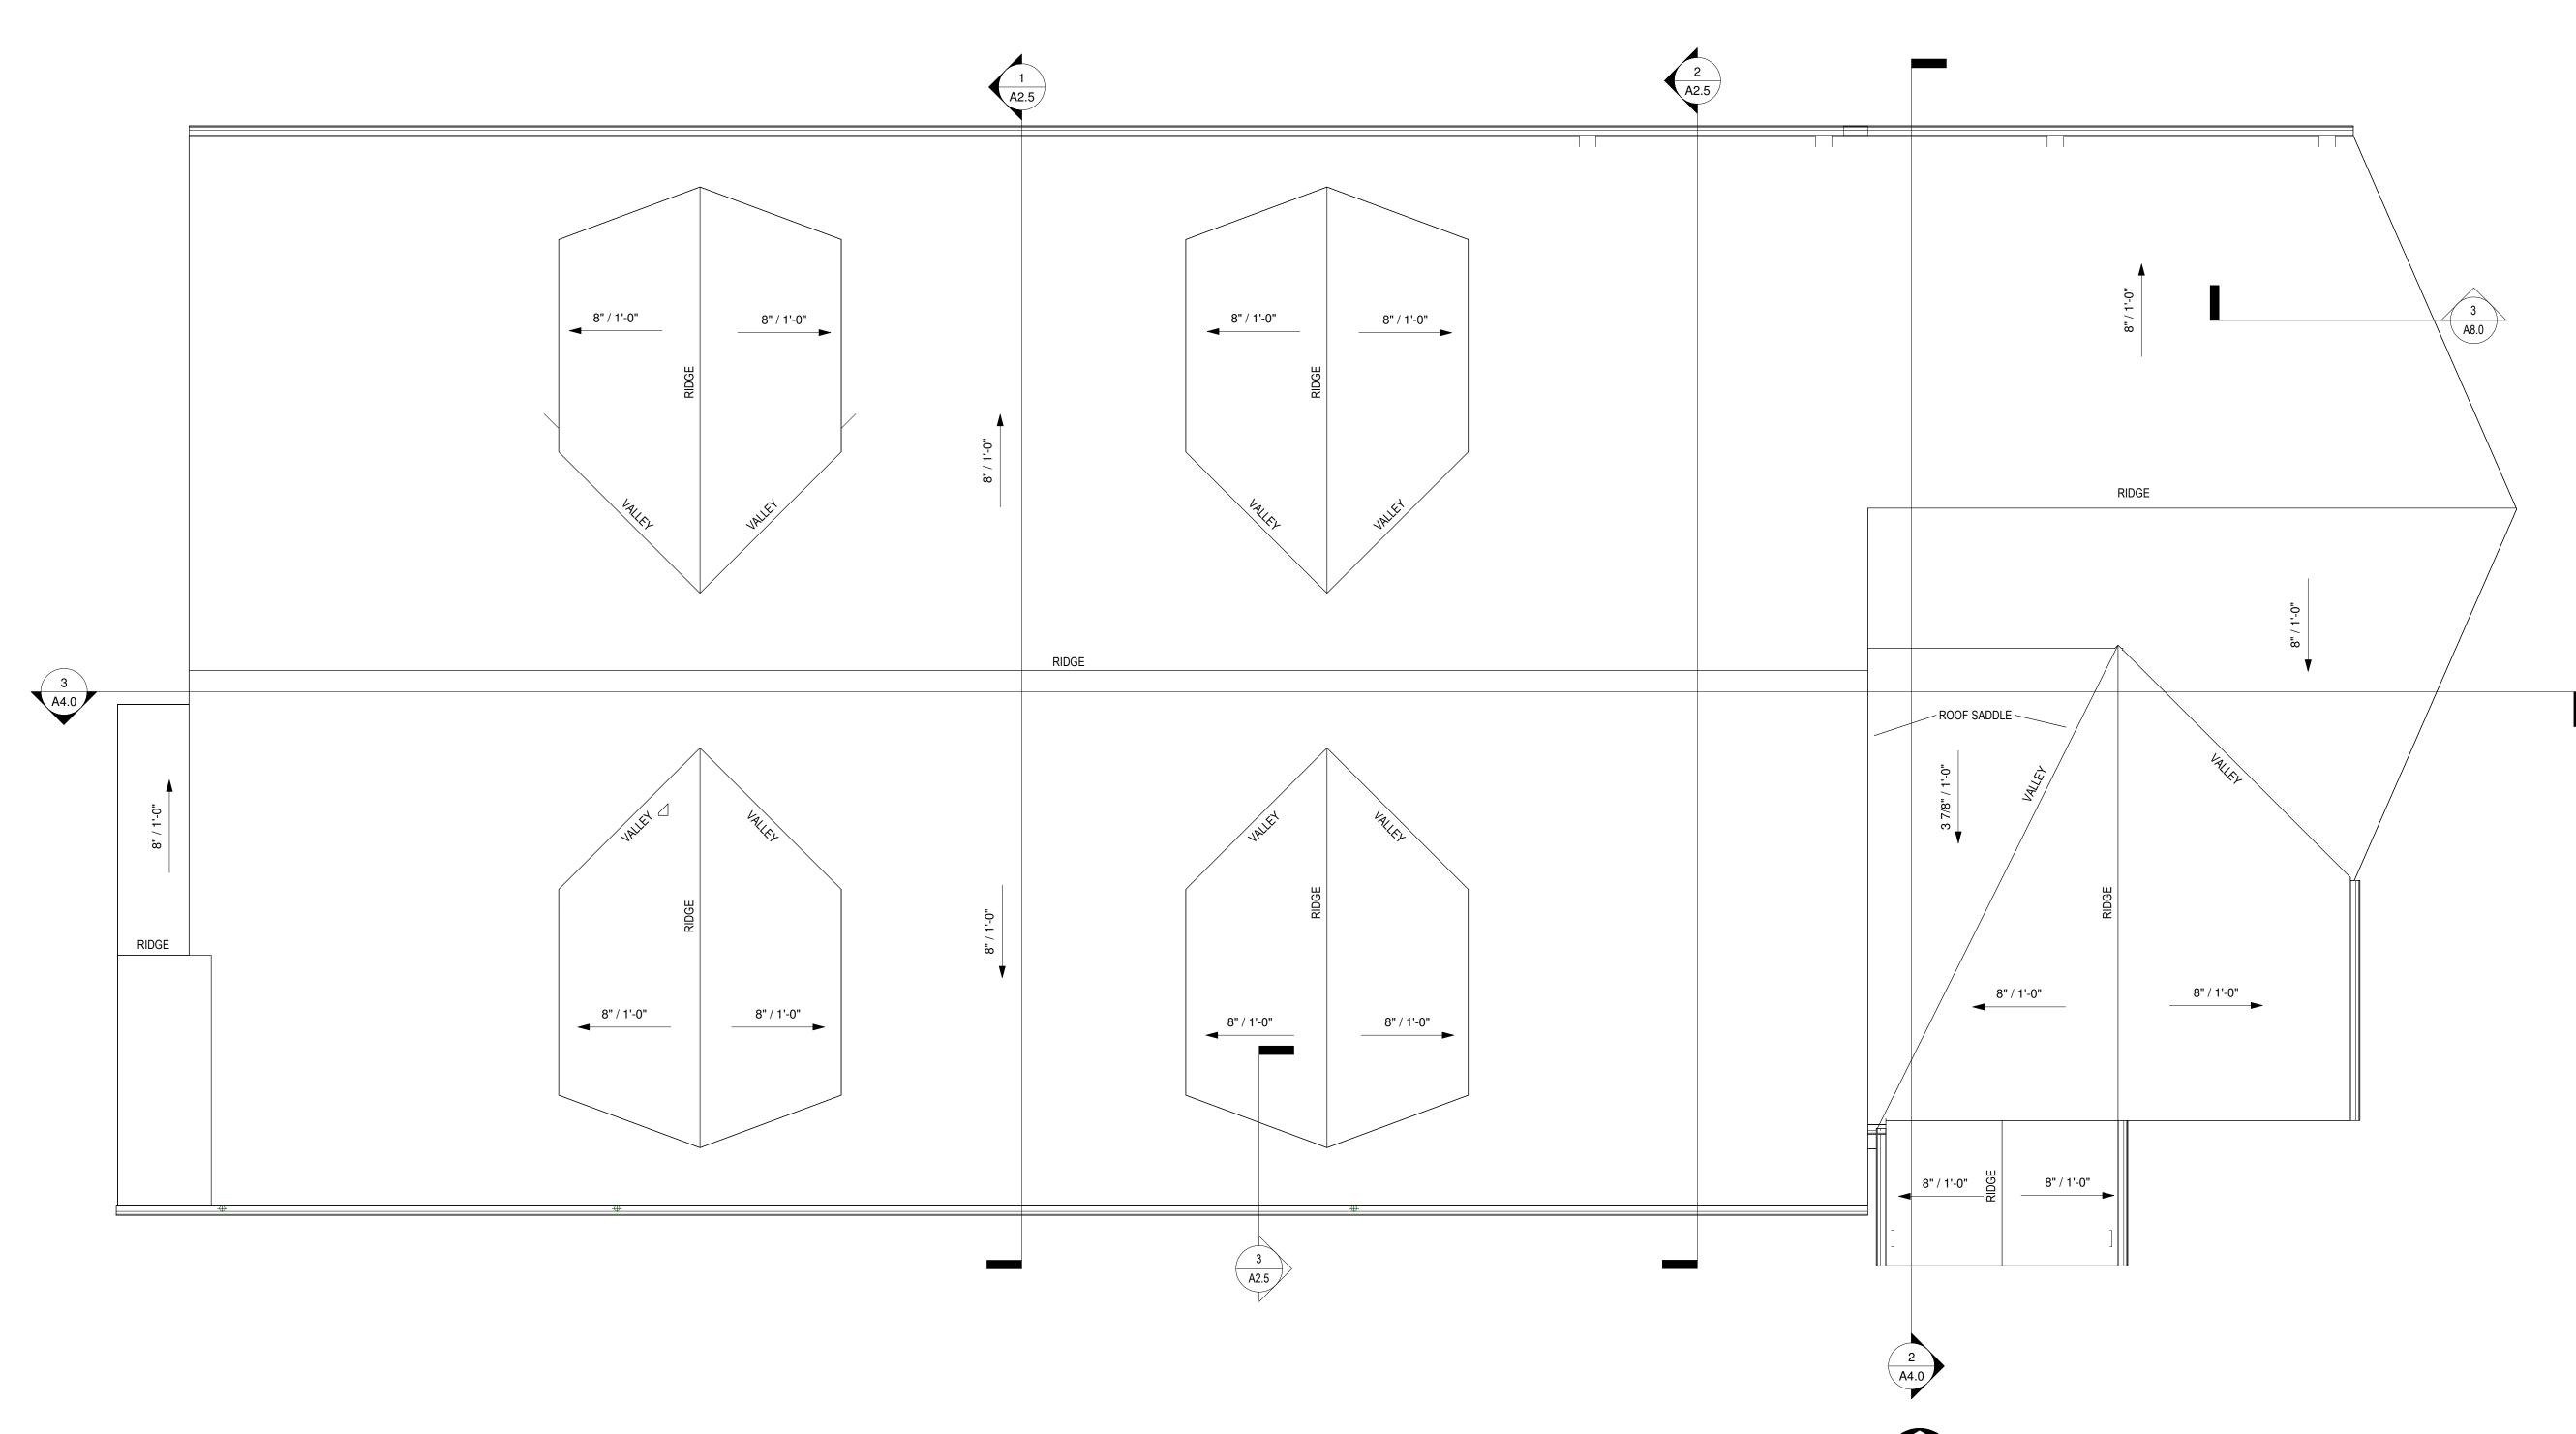
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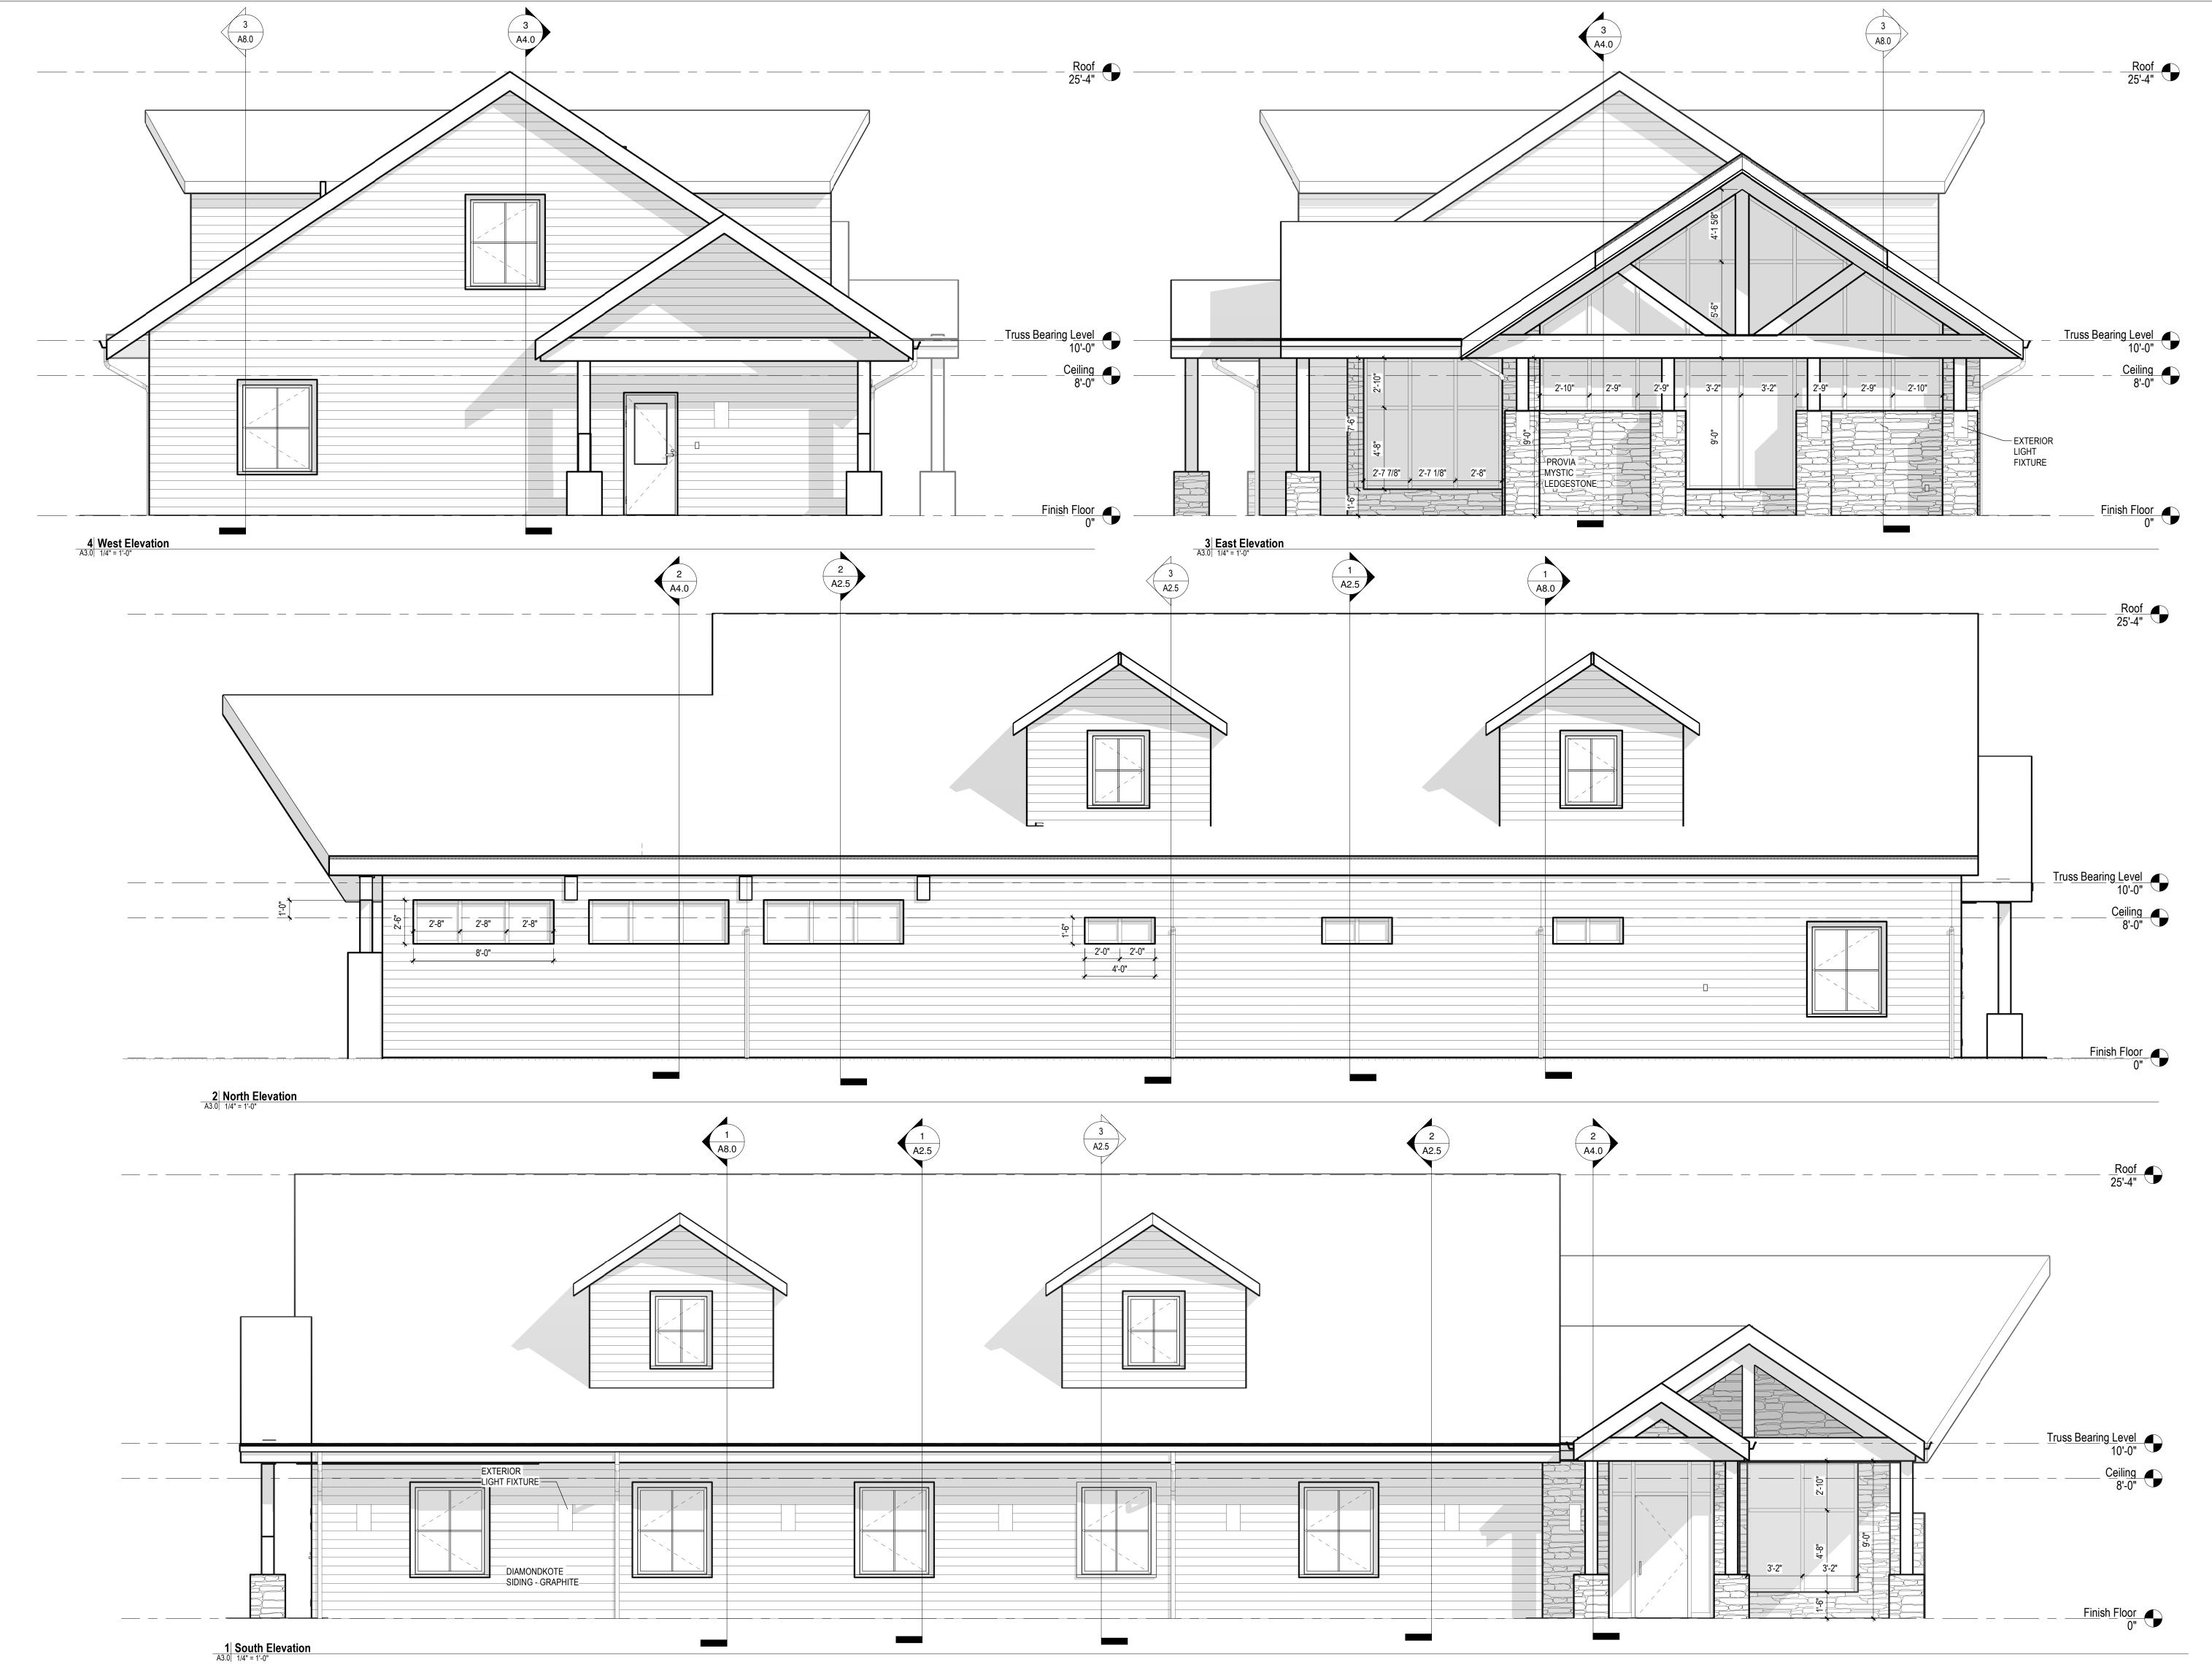


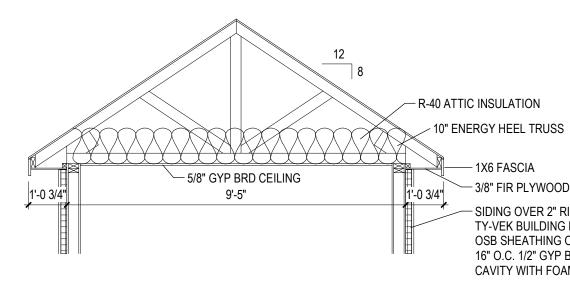



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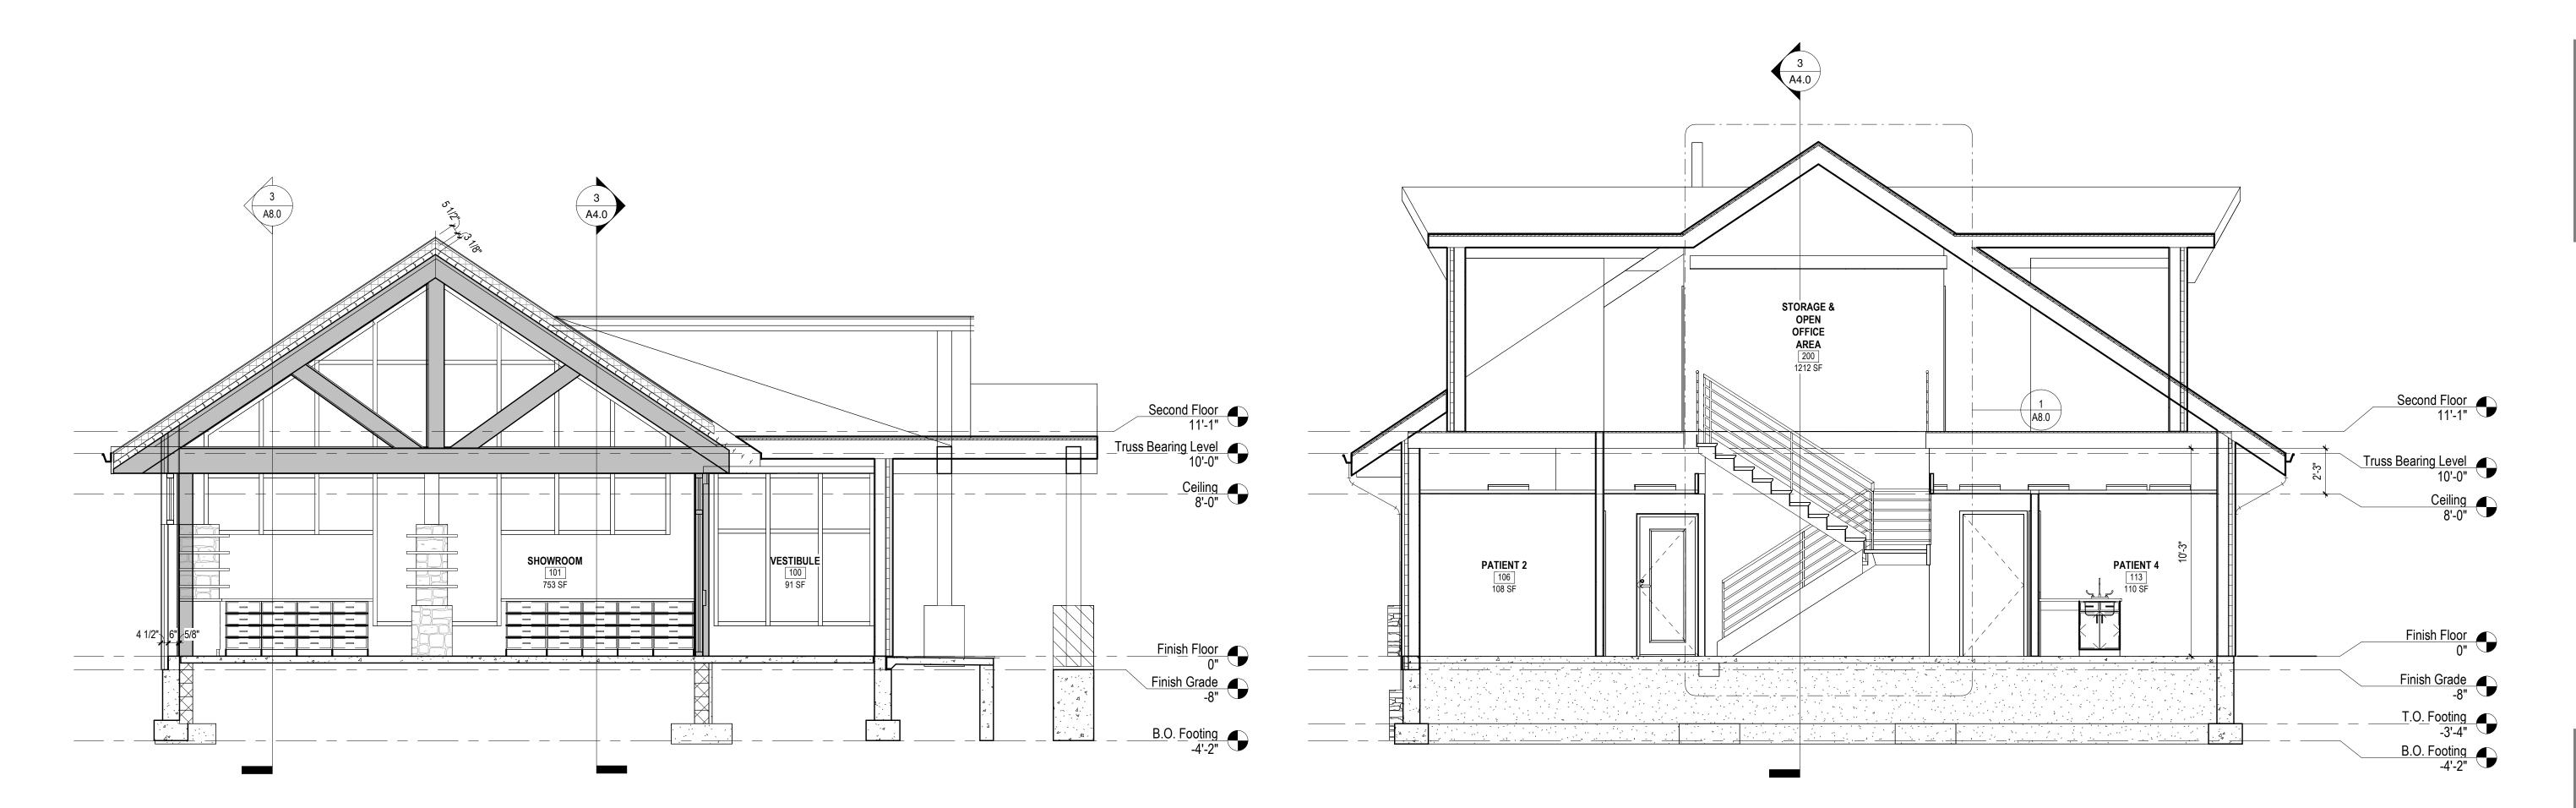
- 3/8" FIR PLYWOOD SOFFIT SIDING OVER 2" RIGID INSULATION OVER TY-VEK BUILDING PAPER WRAP OVER 1/2" OSB SHEATHING OVER 2X4 WD STUDS AT 16" O.C. 1/2" GYP BRD INTERIOR FILL CAVITY WITH FOAM INSULATION

– 1X6 FASCIA

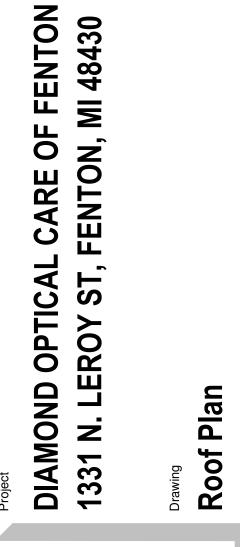




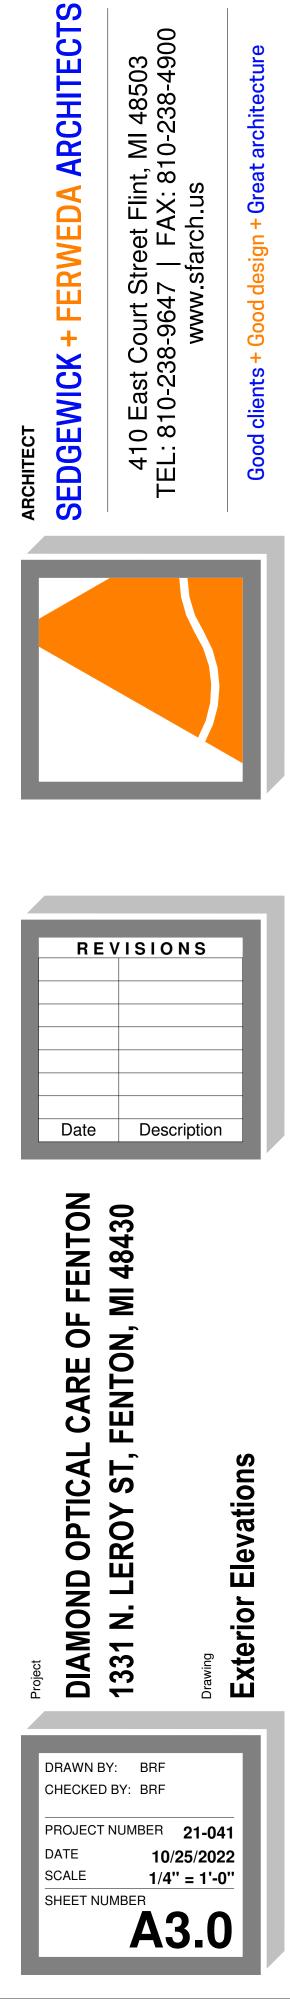


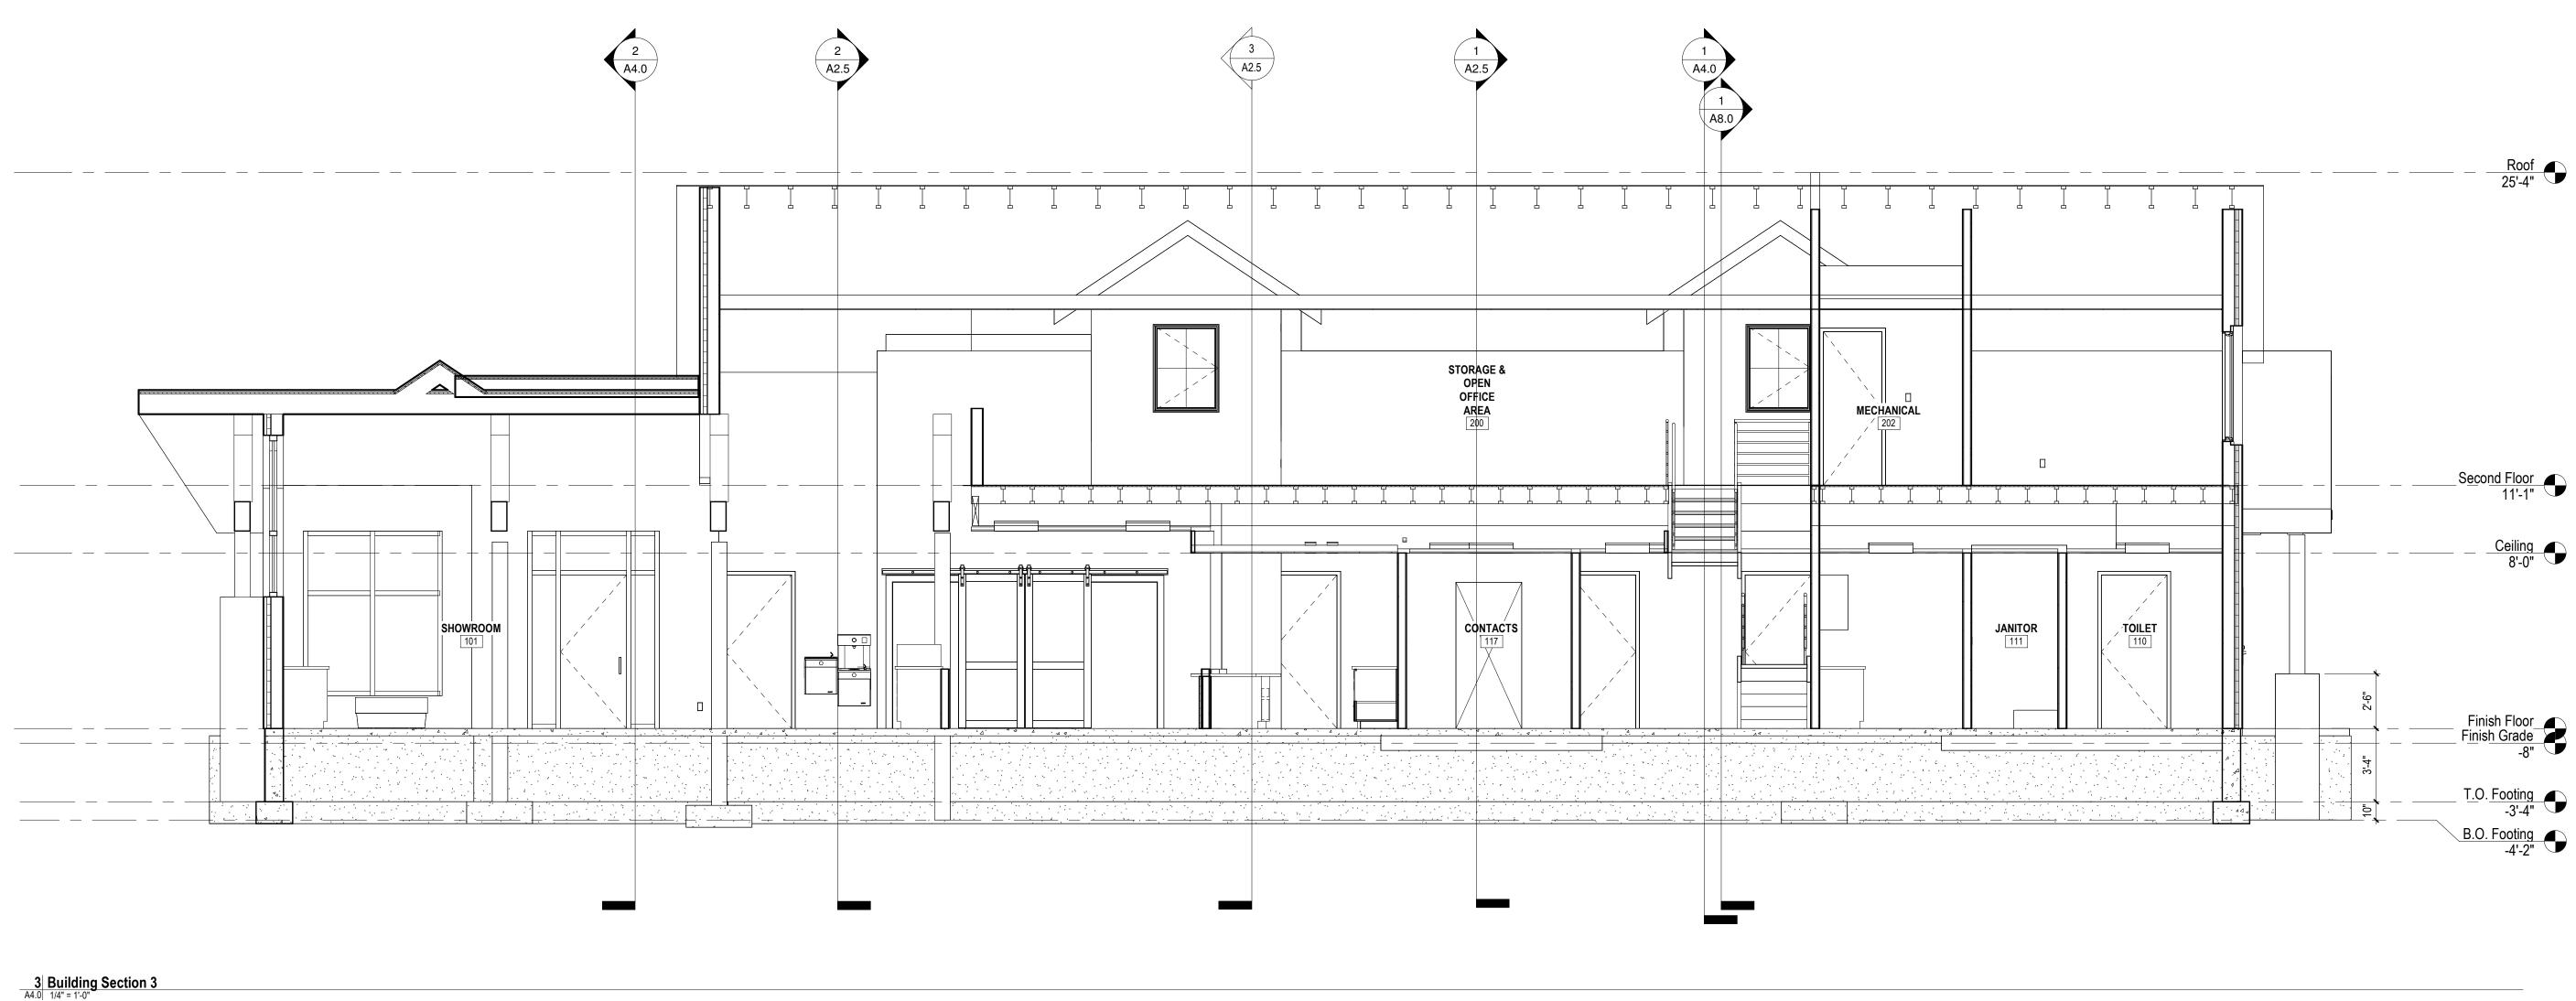






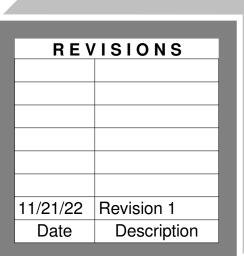


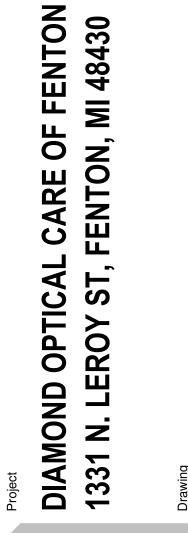



Building Sections

DRAWN BY: SJS CHECKED BY: BRF PROJECT NUMBER 21-041 10/25/2022 1/4" = 1'-0" DATE SCALE SHEET NUMBER A4.0

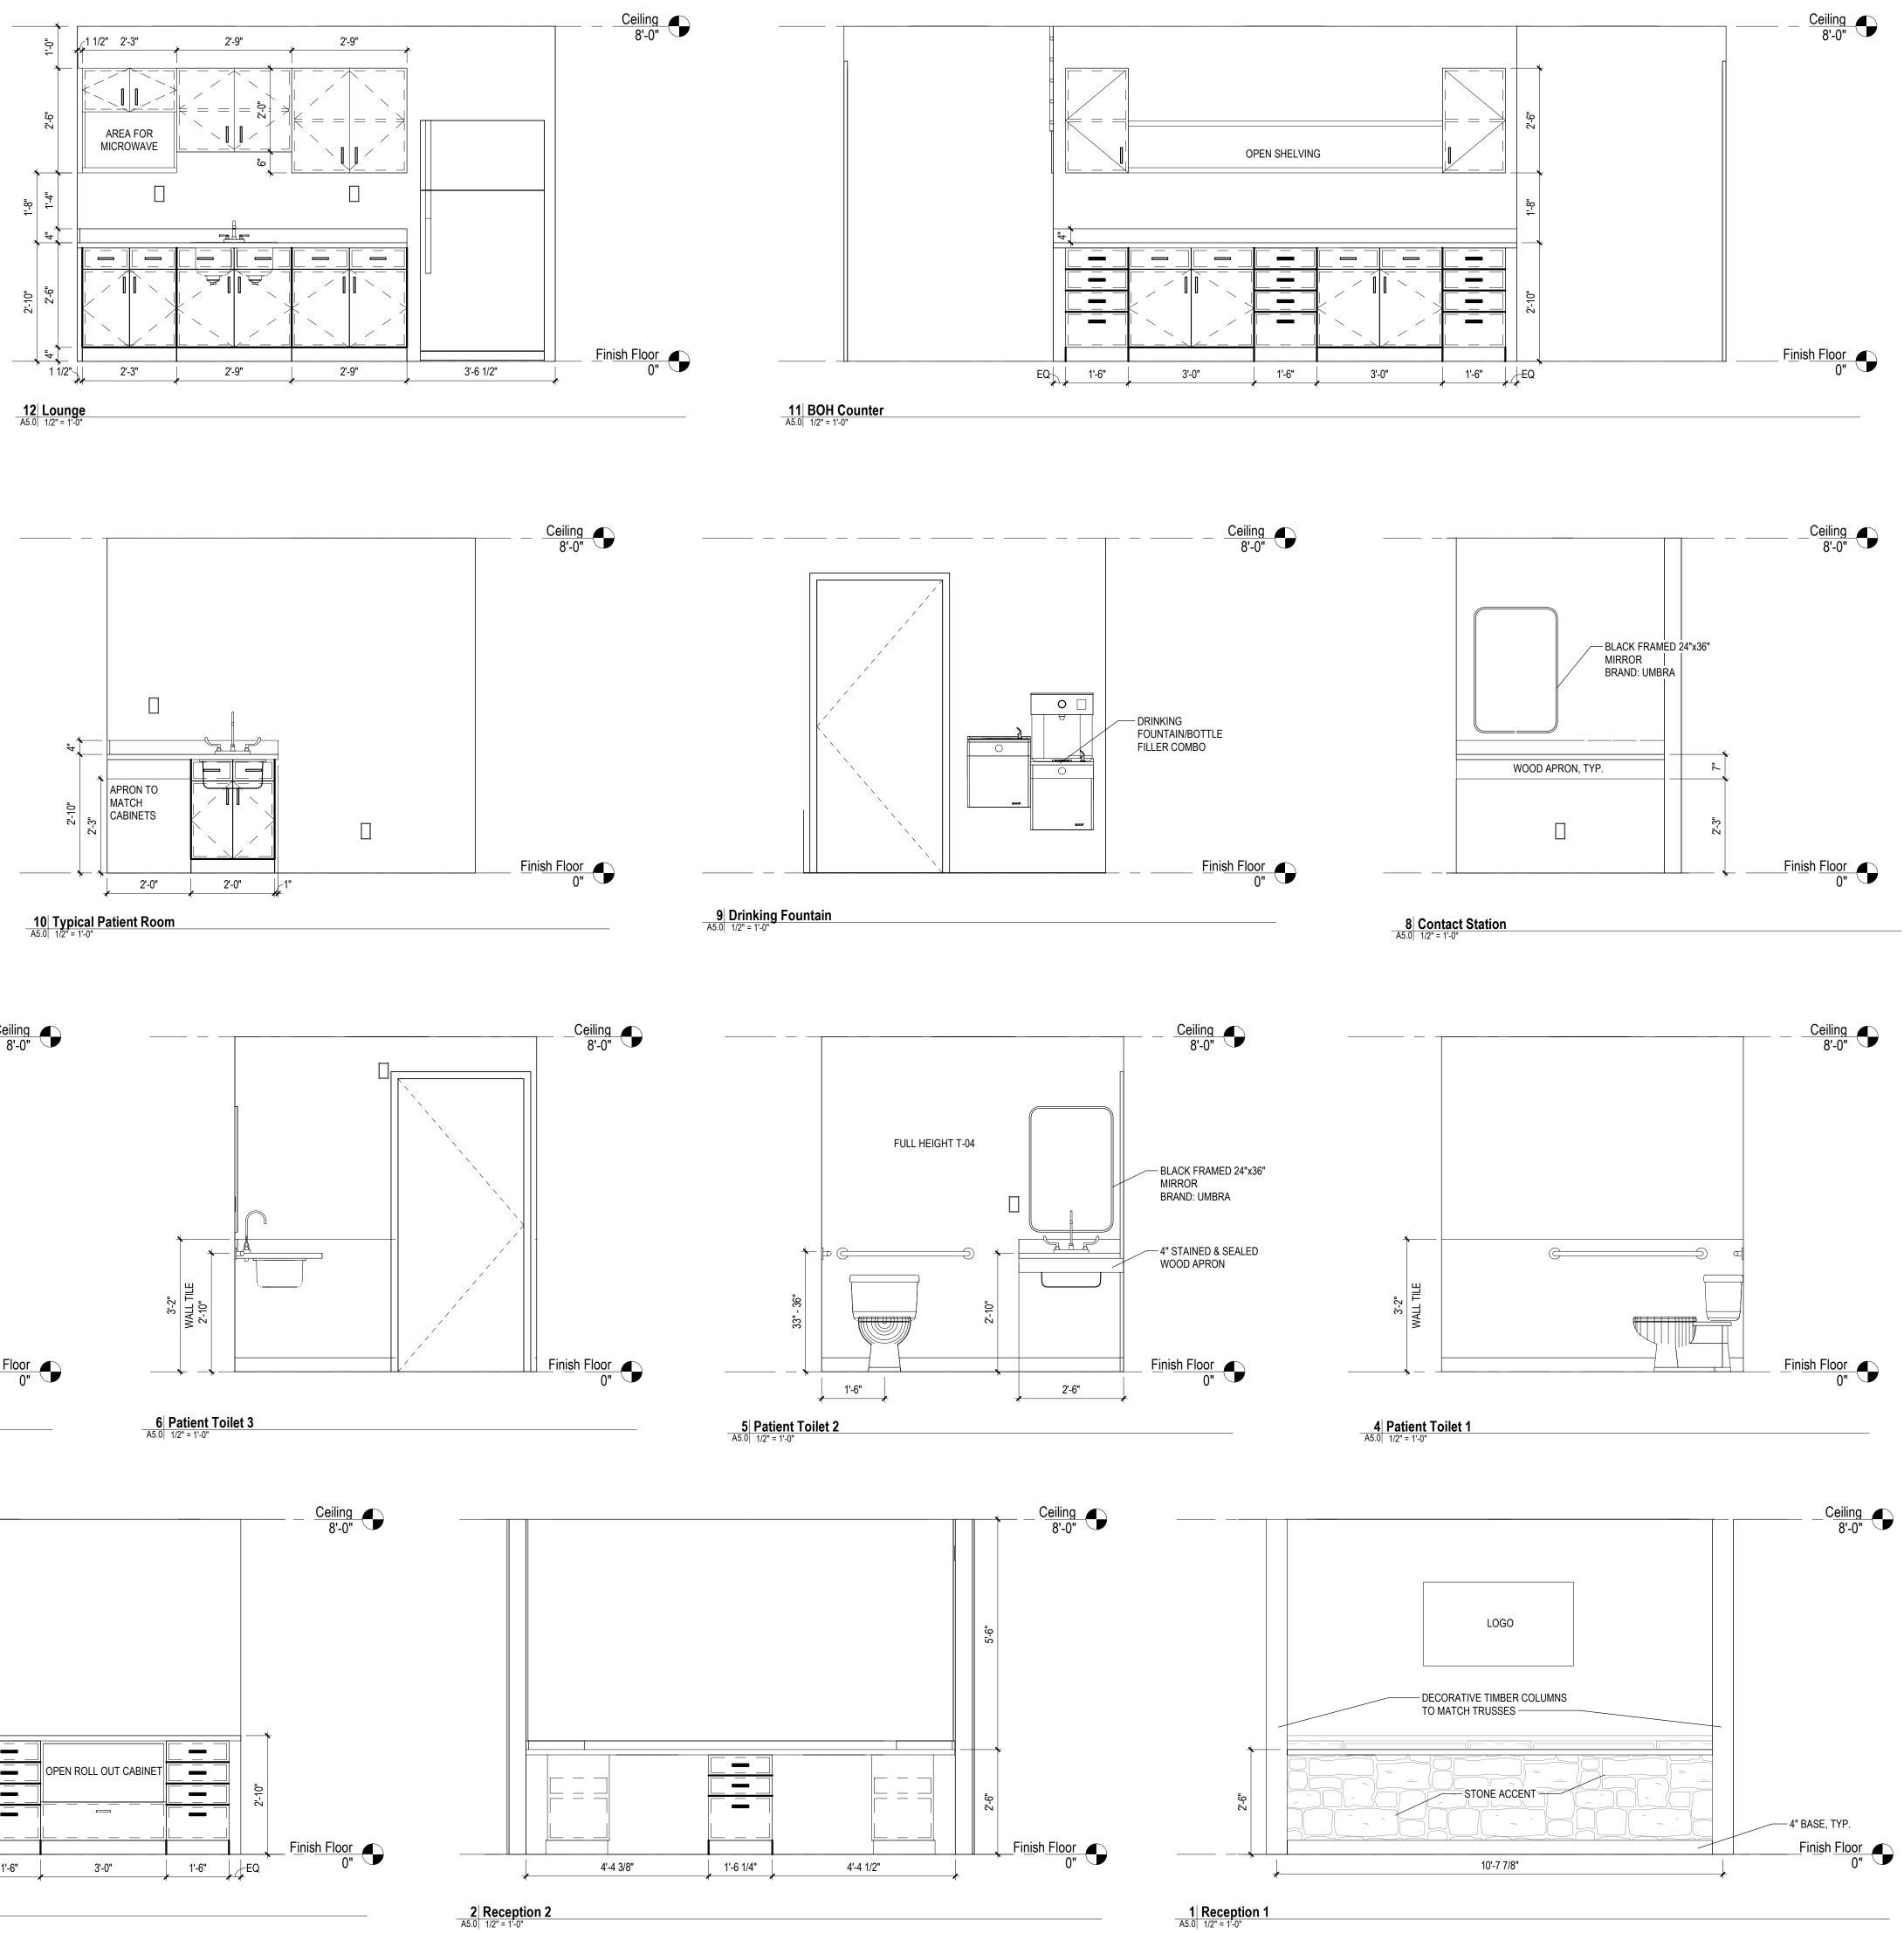


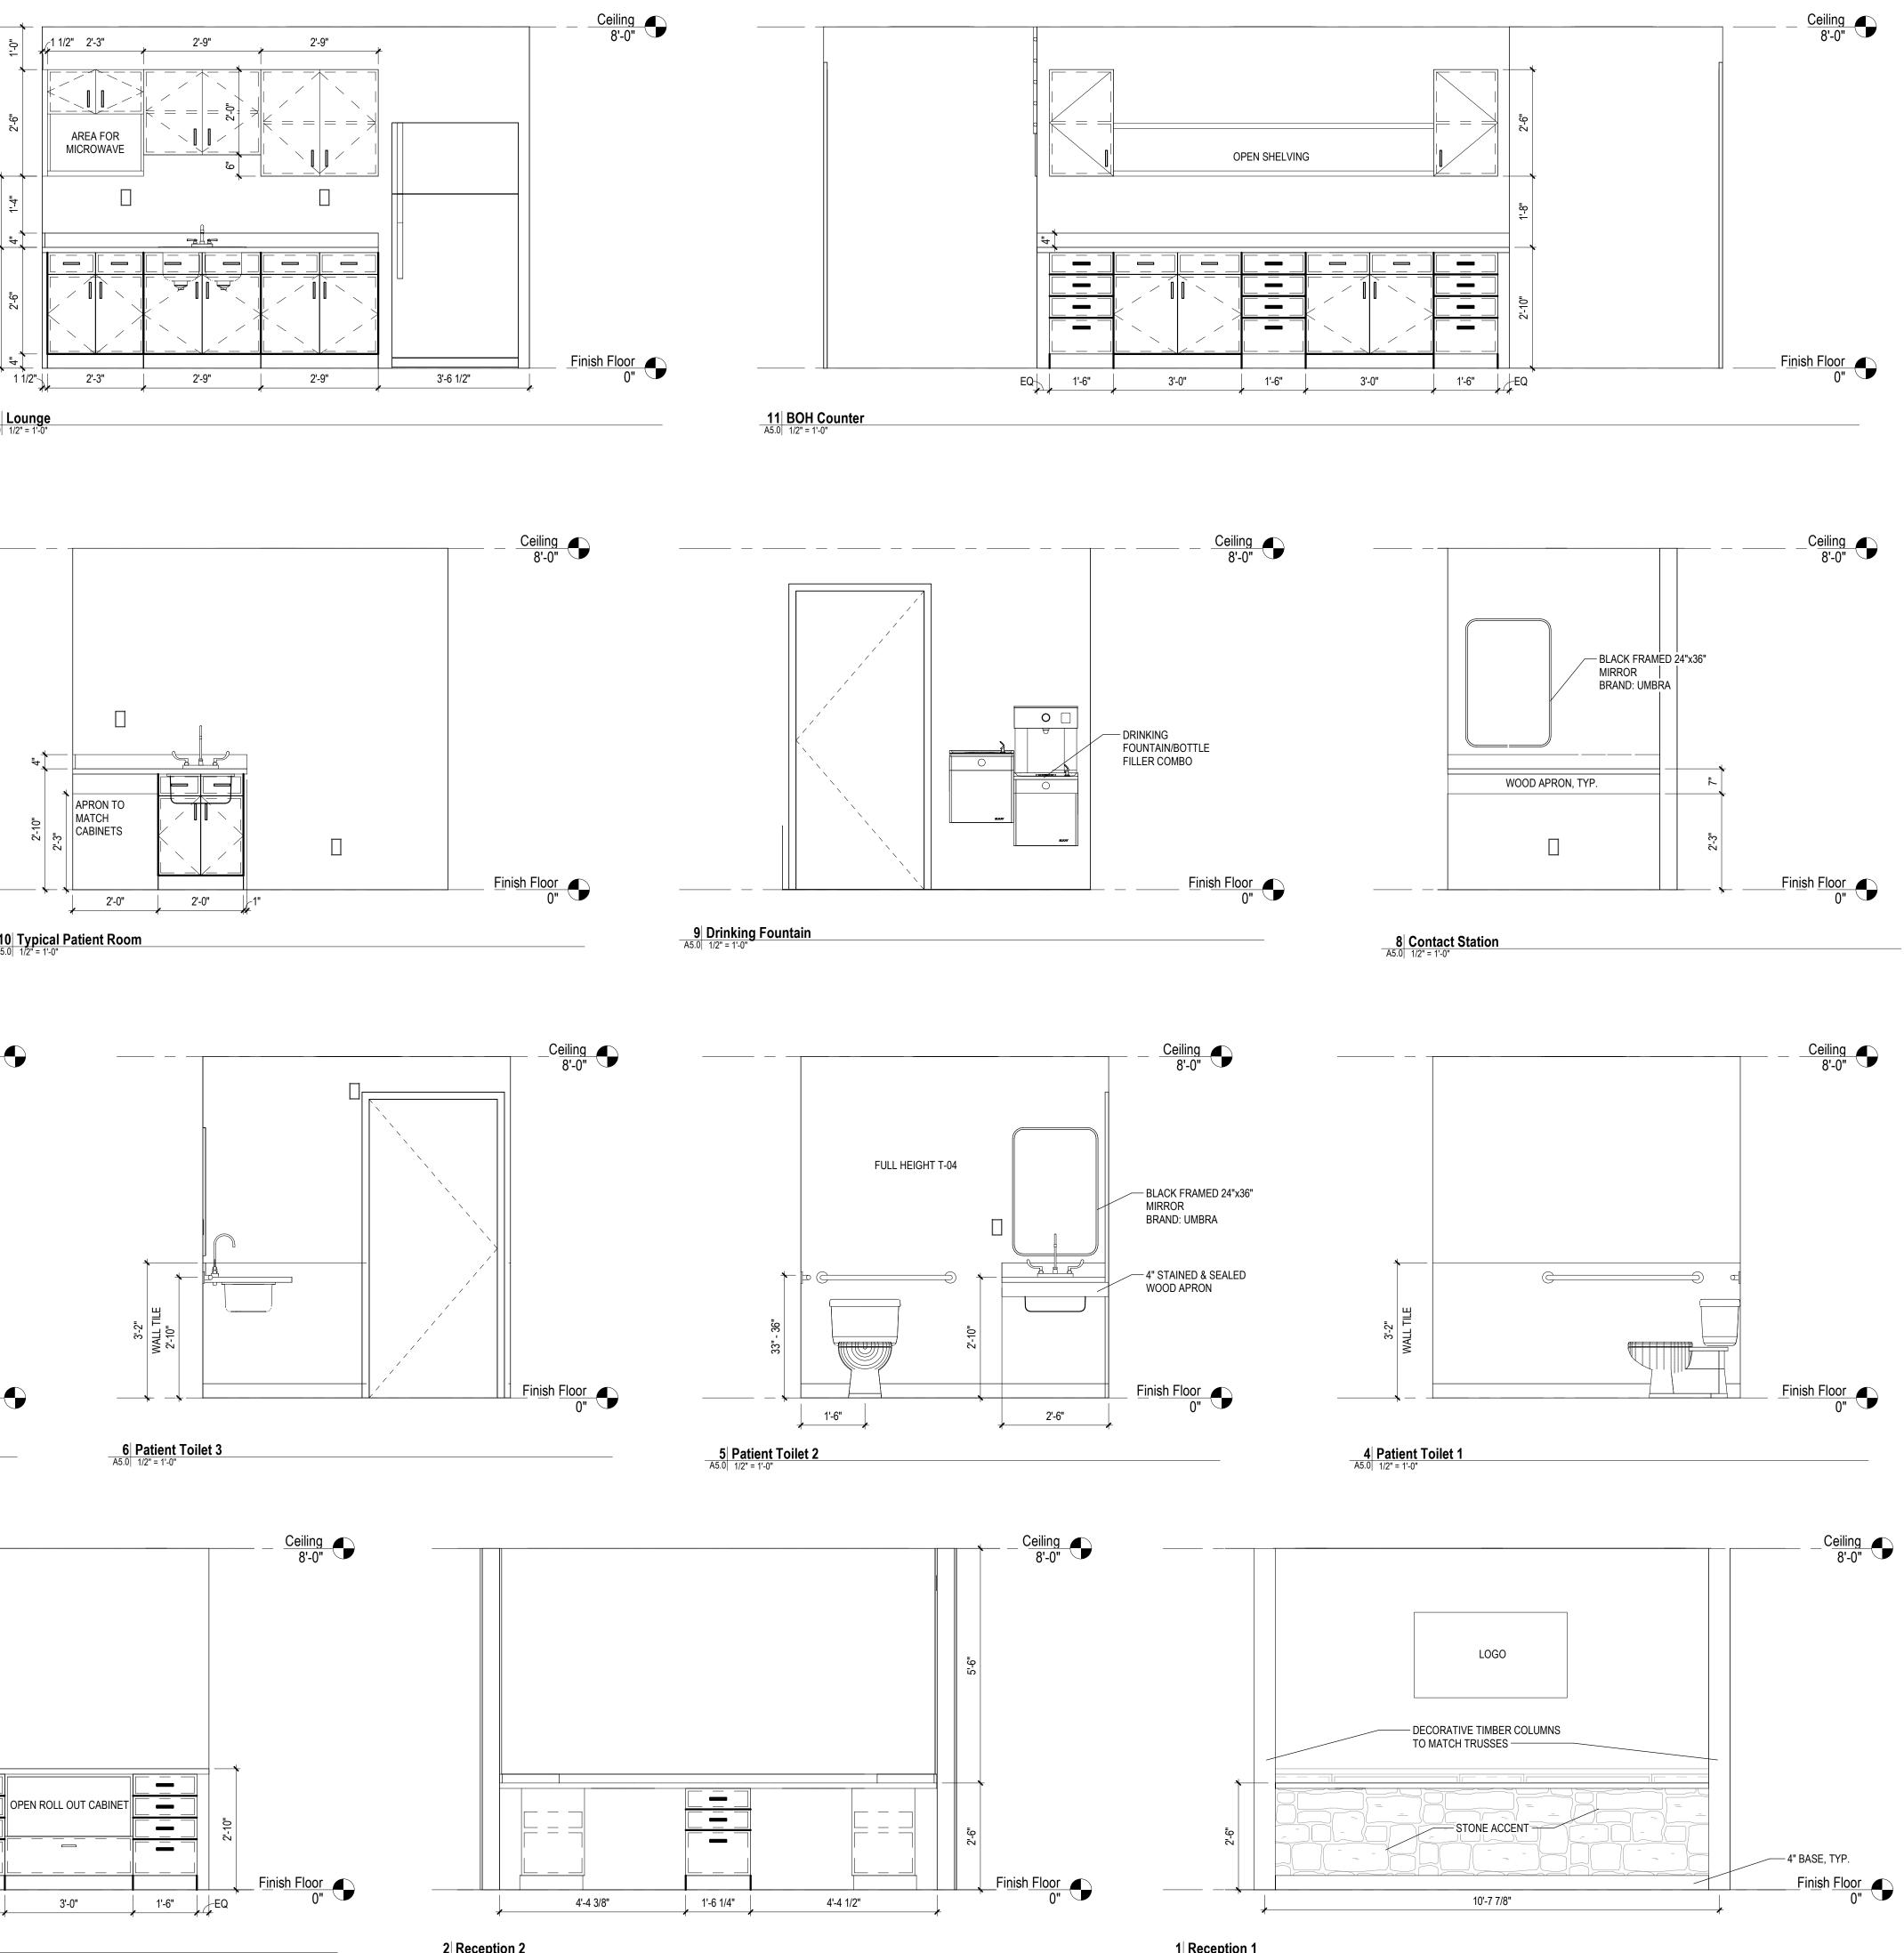

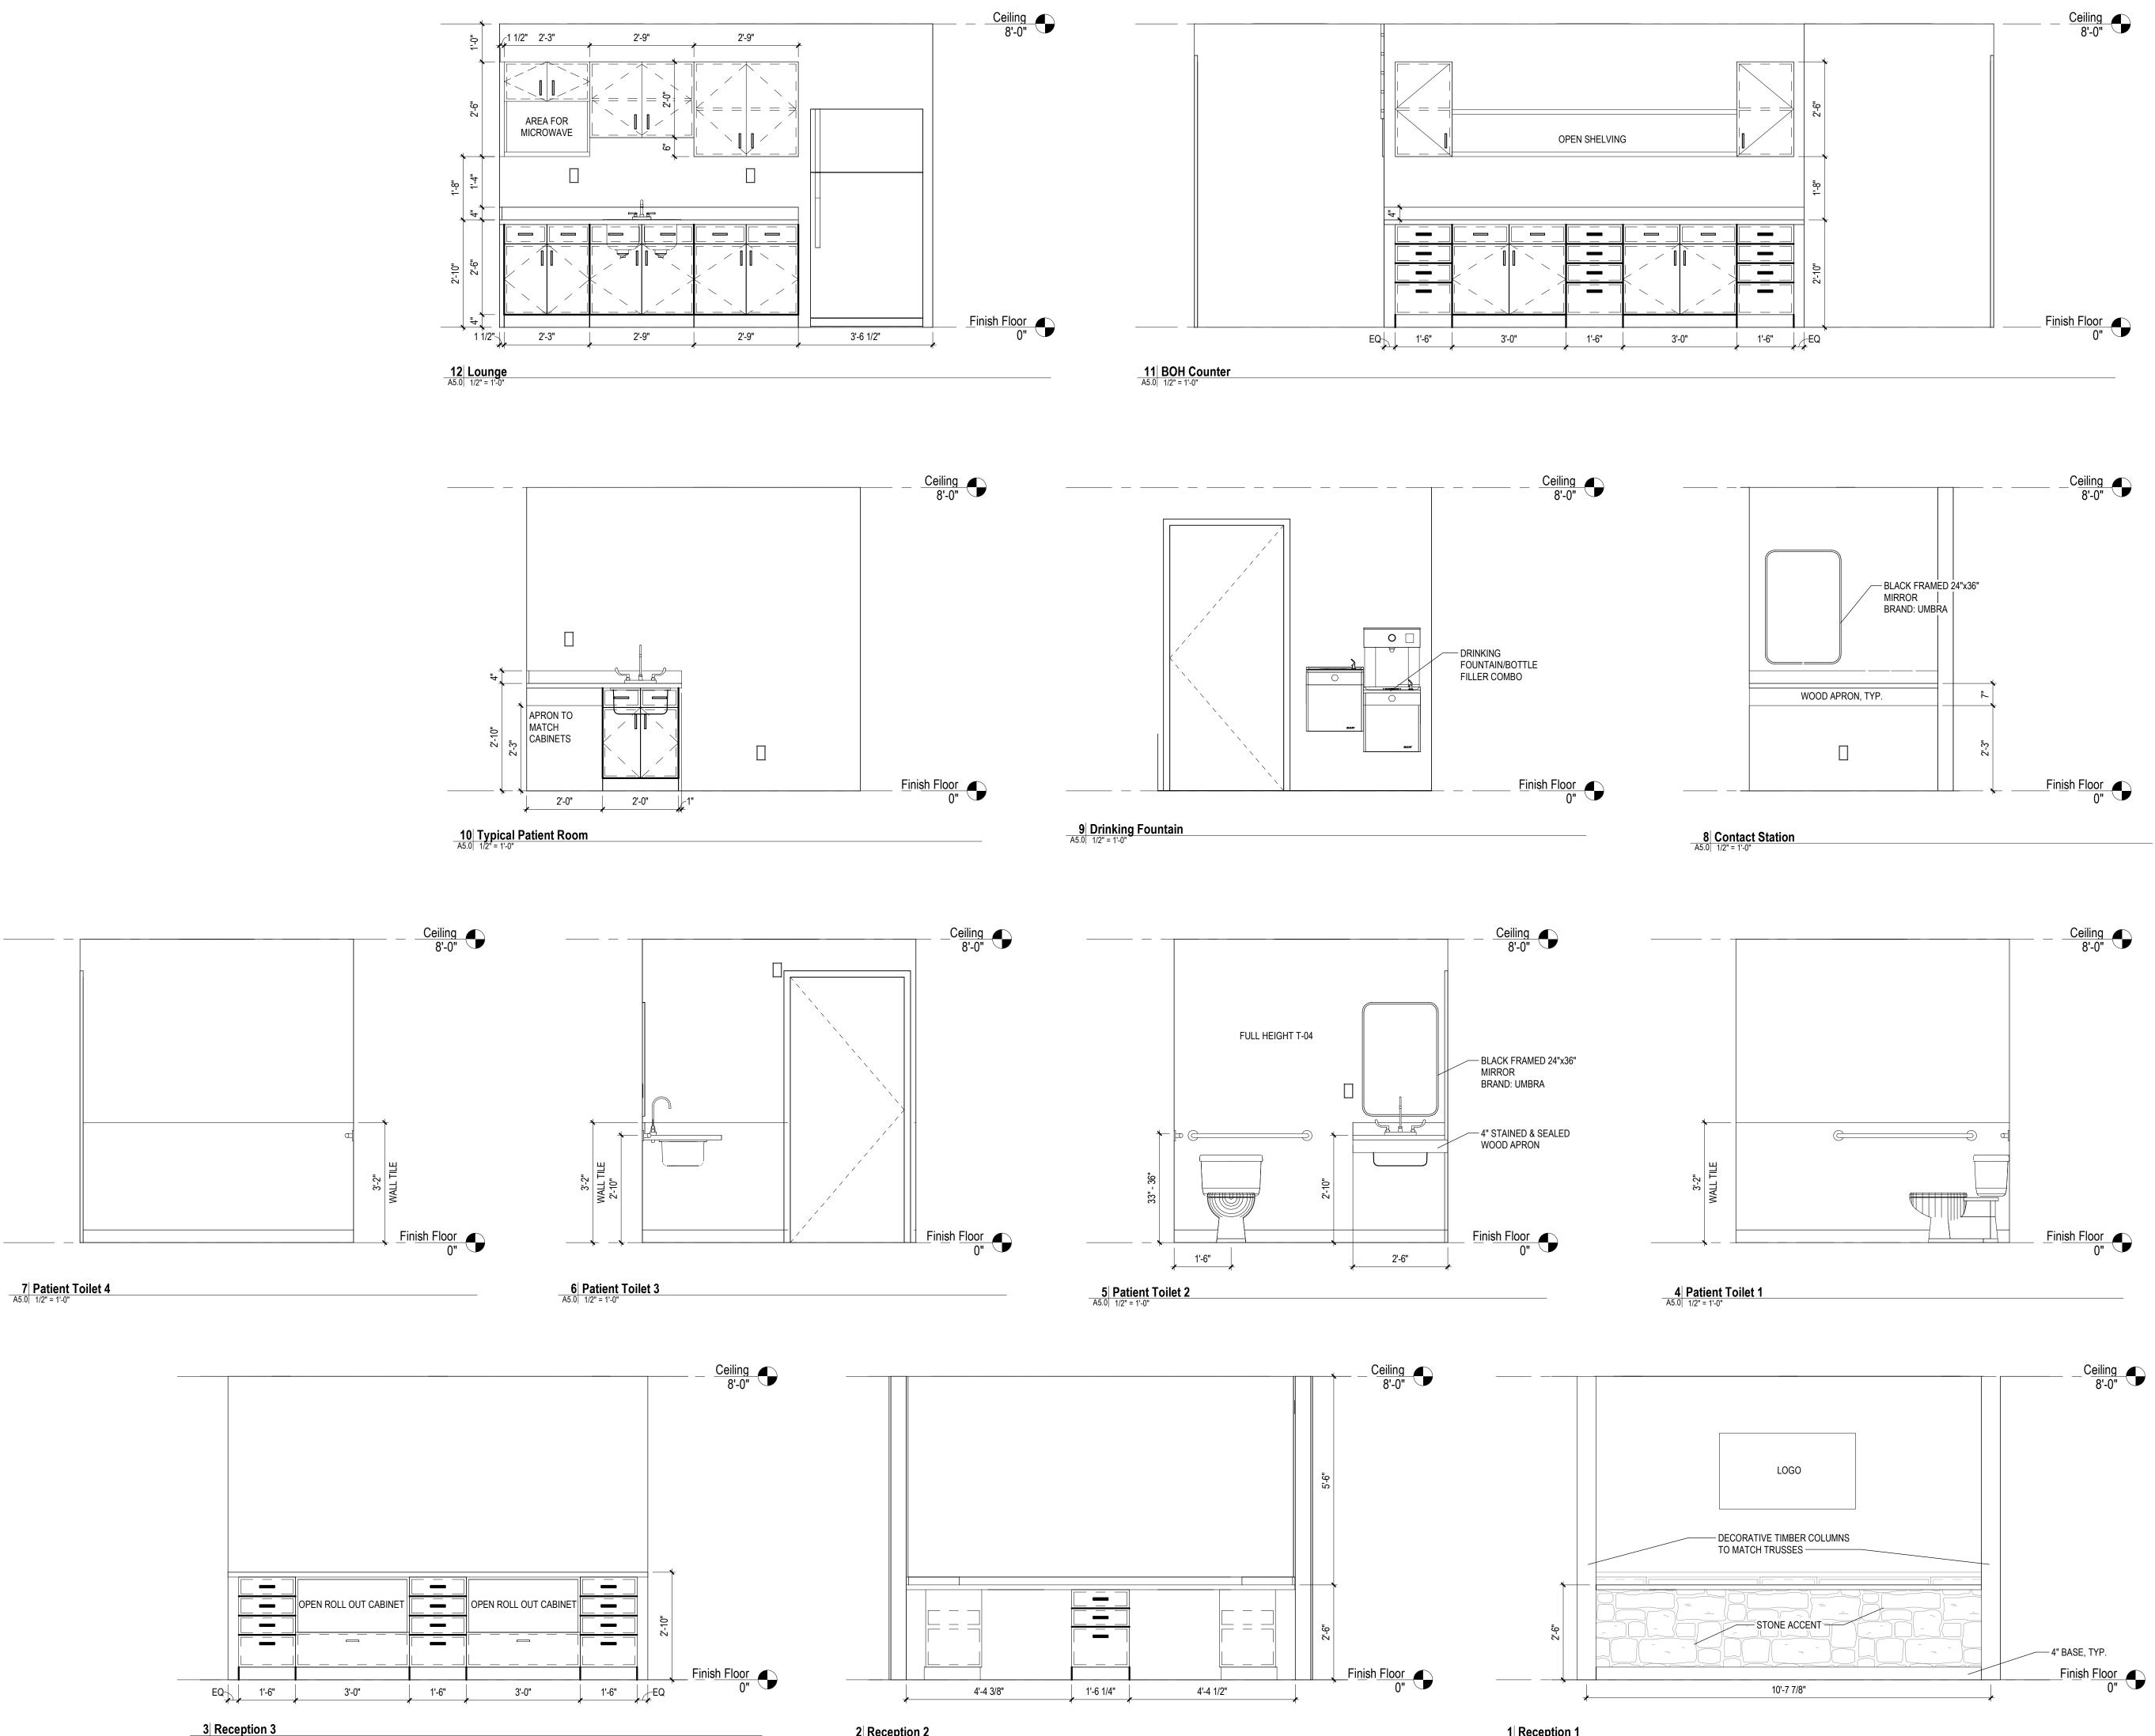


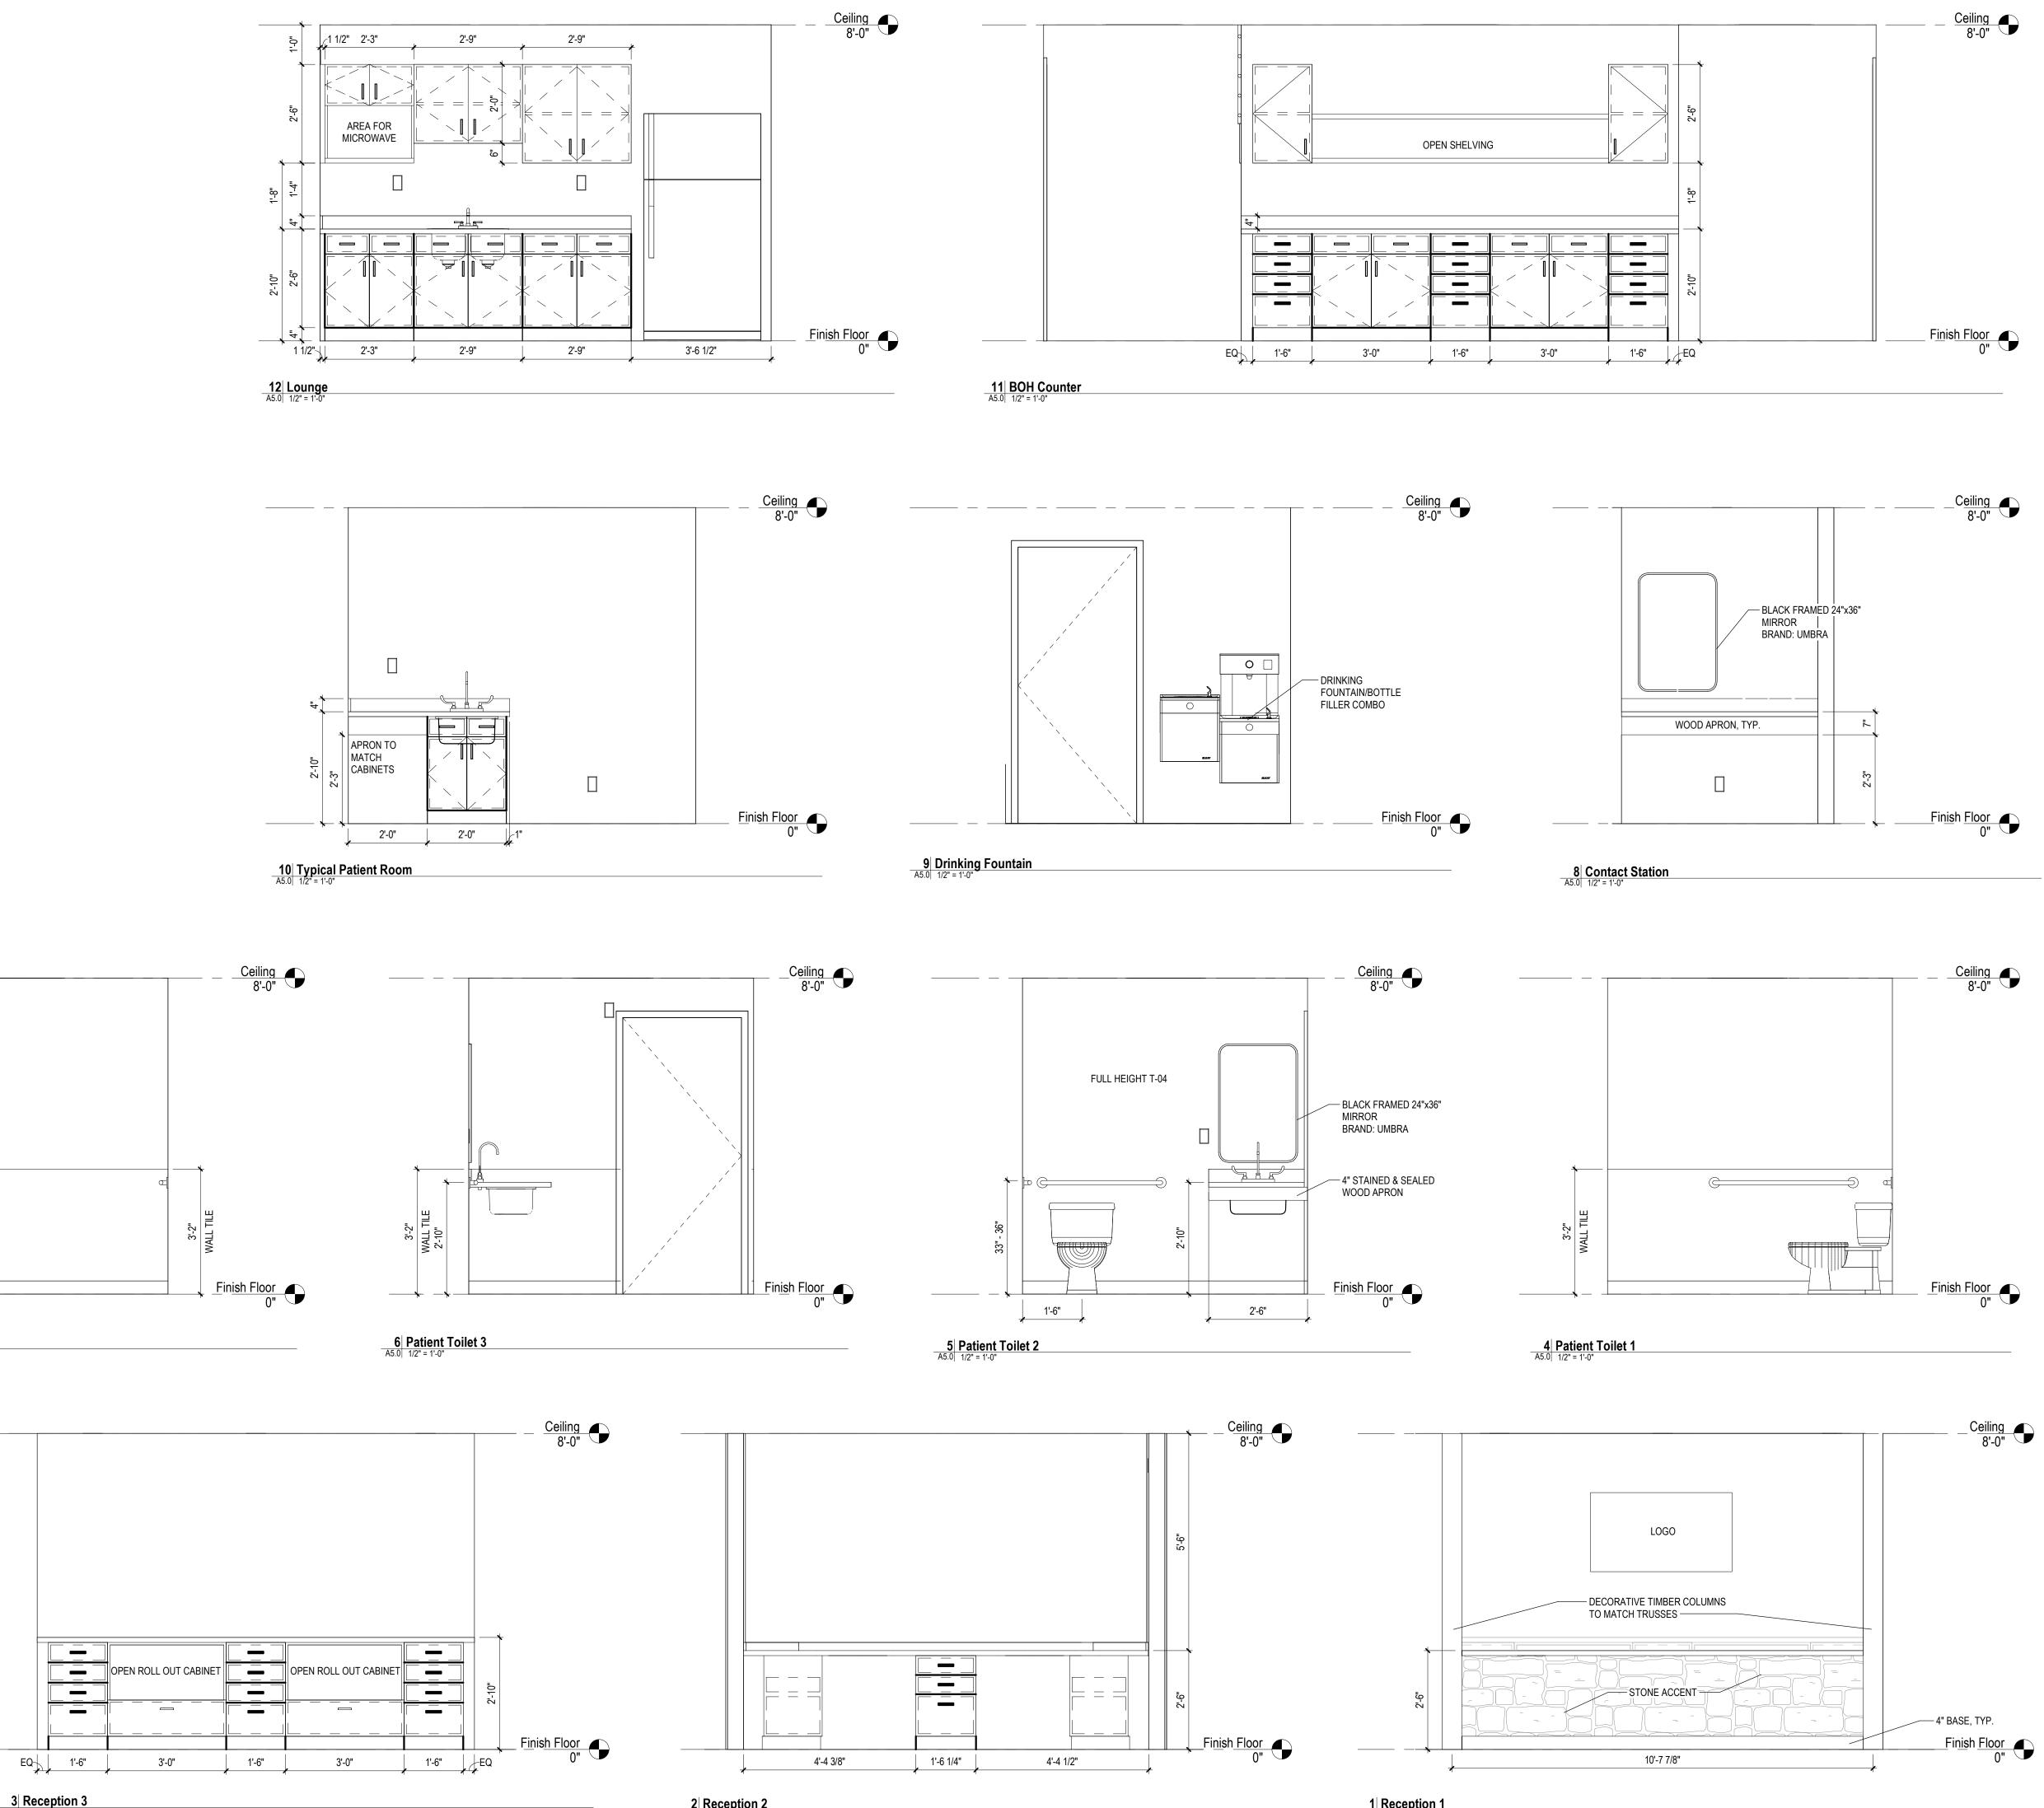


3 Reception 3 A5.0 1/2" = 1'-0"

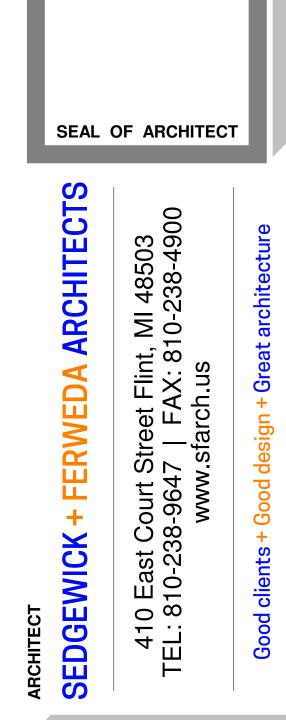



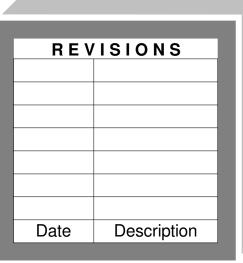

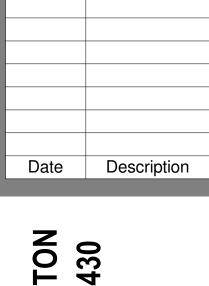





Elevations Interior

PROJECT NUMBER 21-041 DATE SCALE SHEET NUMBER A5.0


10/25/2022 1/2'' = 1'-0''

DRAWN BY: LJK CHECKED BY: BRF

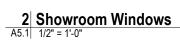


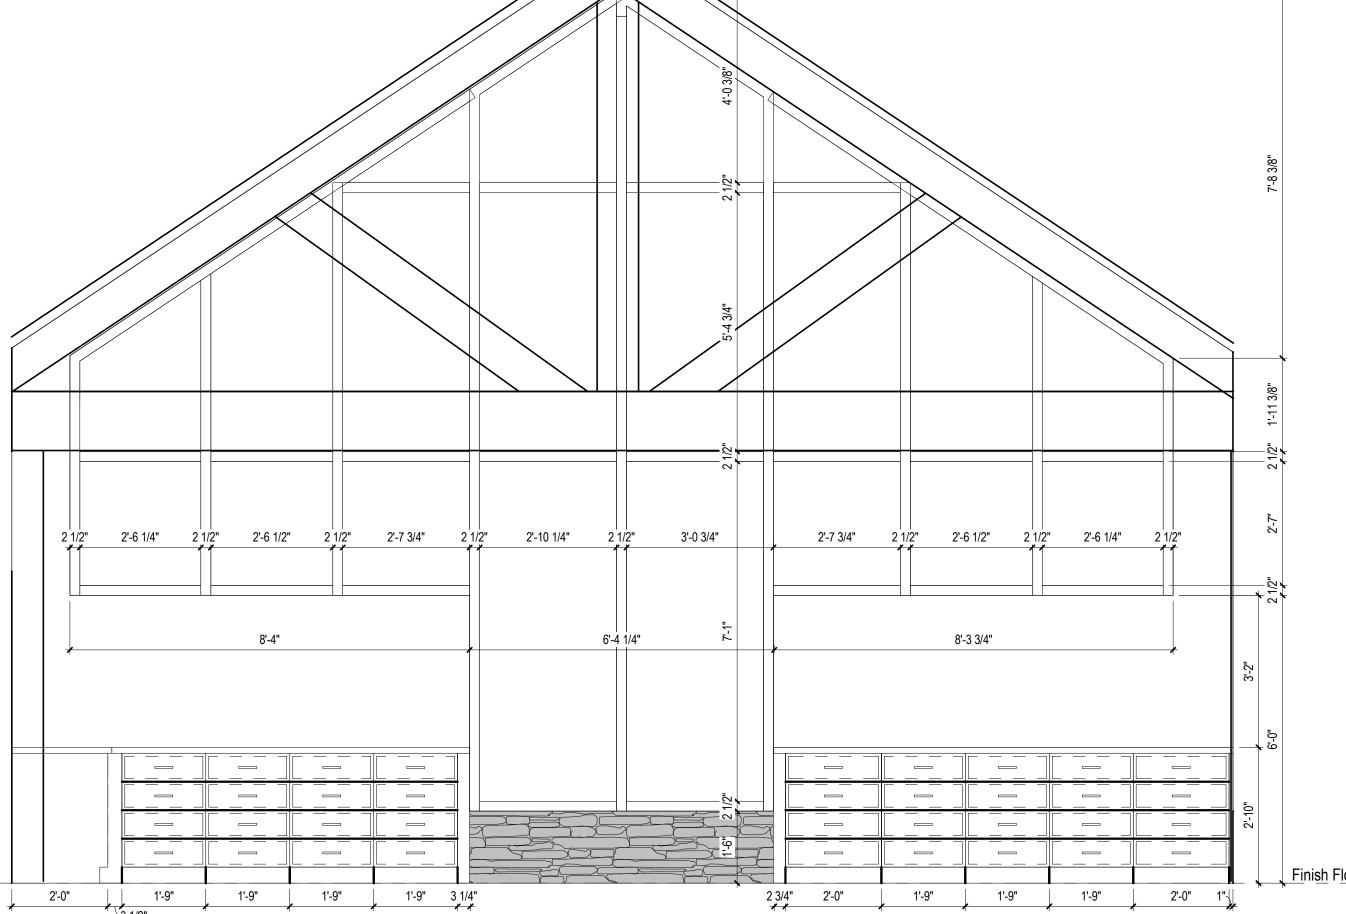



	GLASS DIS	PLAY CASE			
				2'-10"	

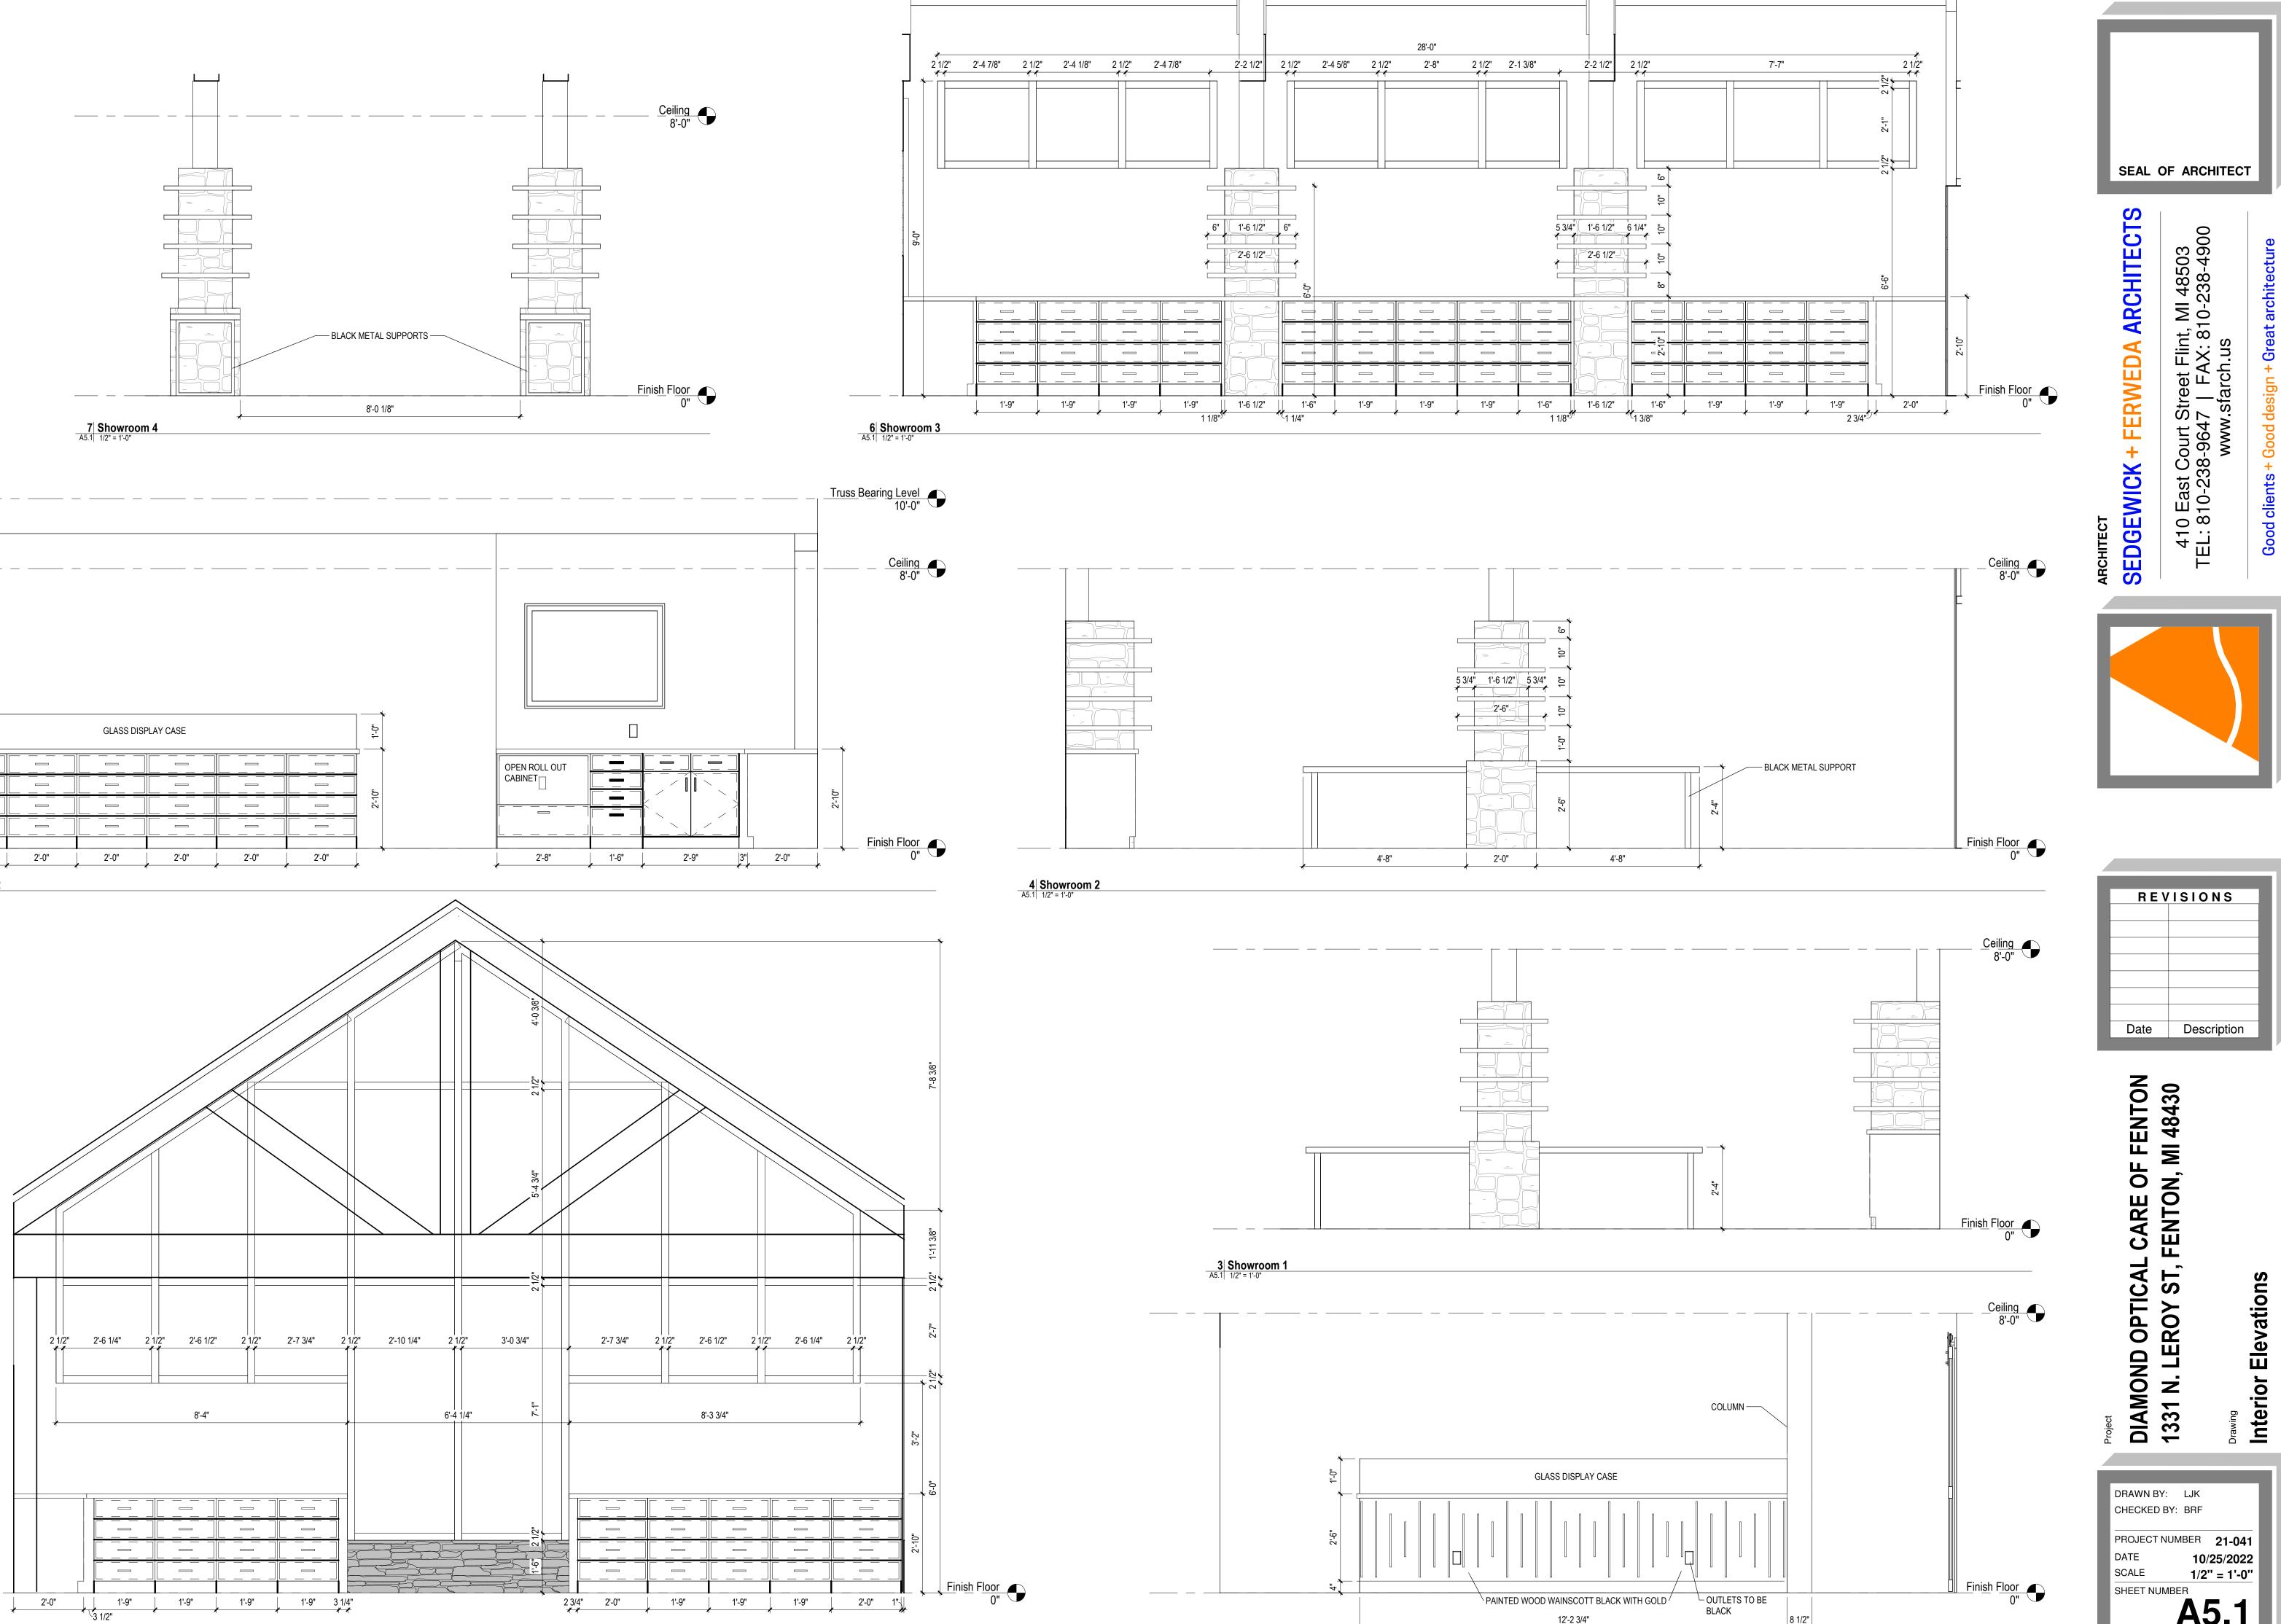





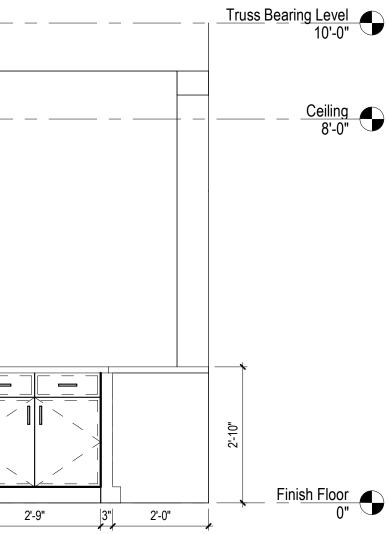

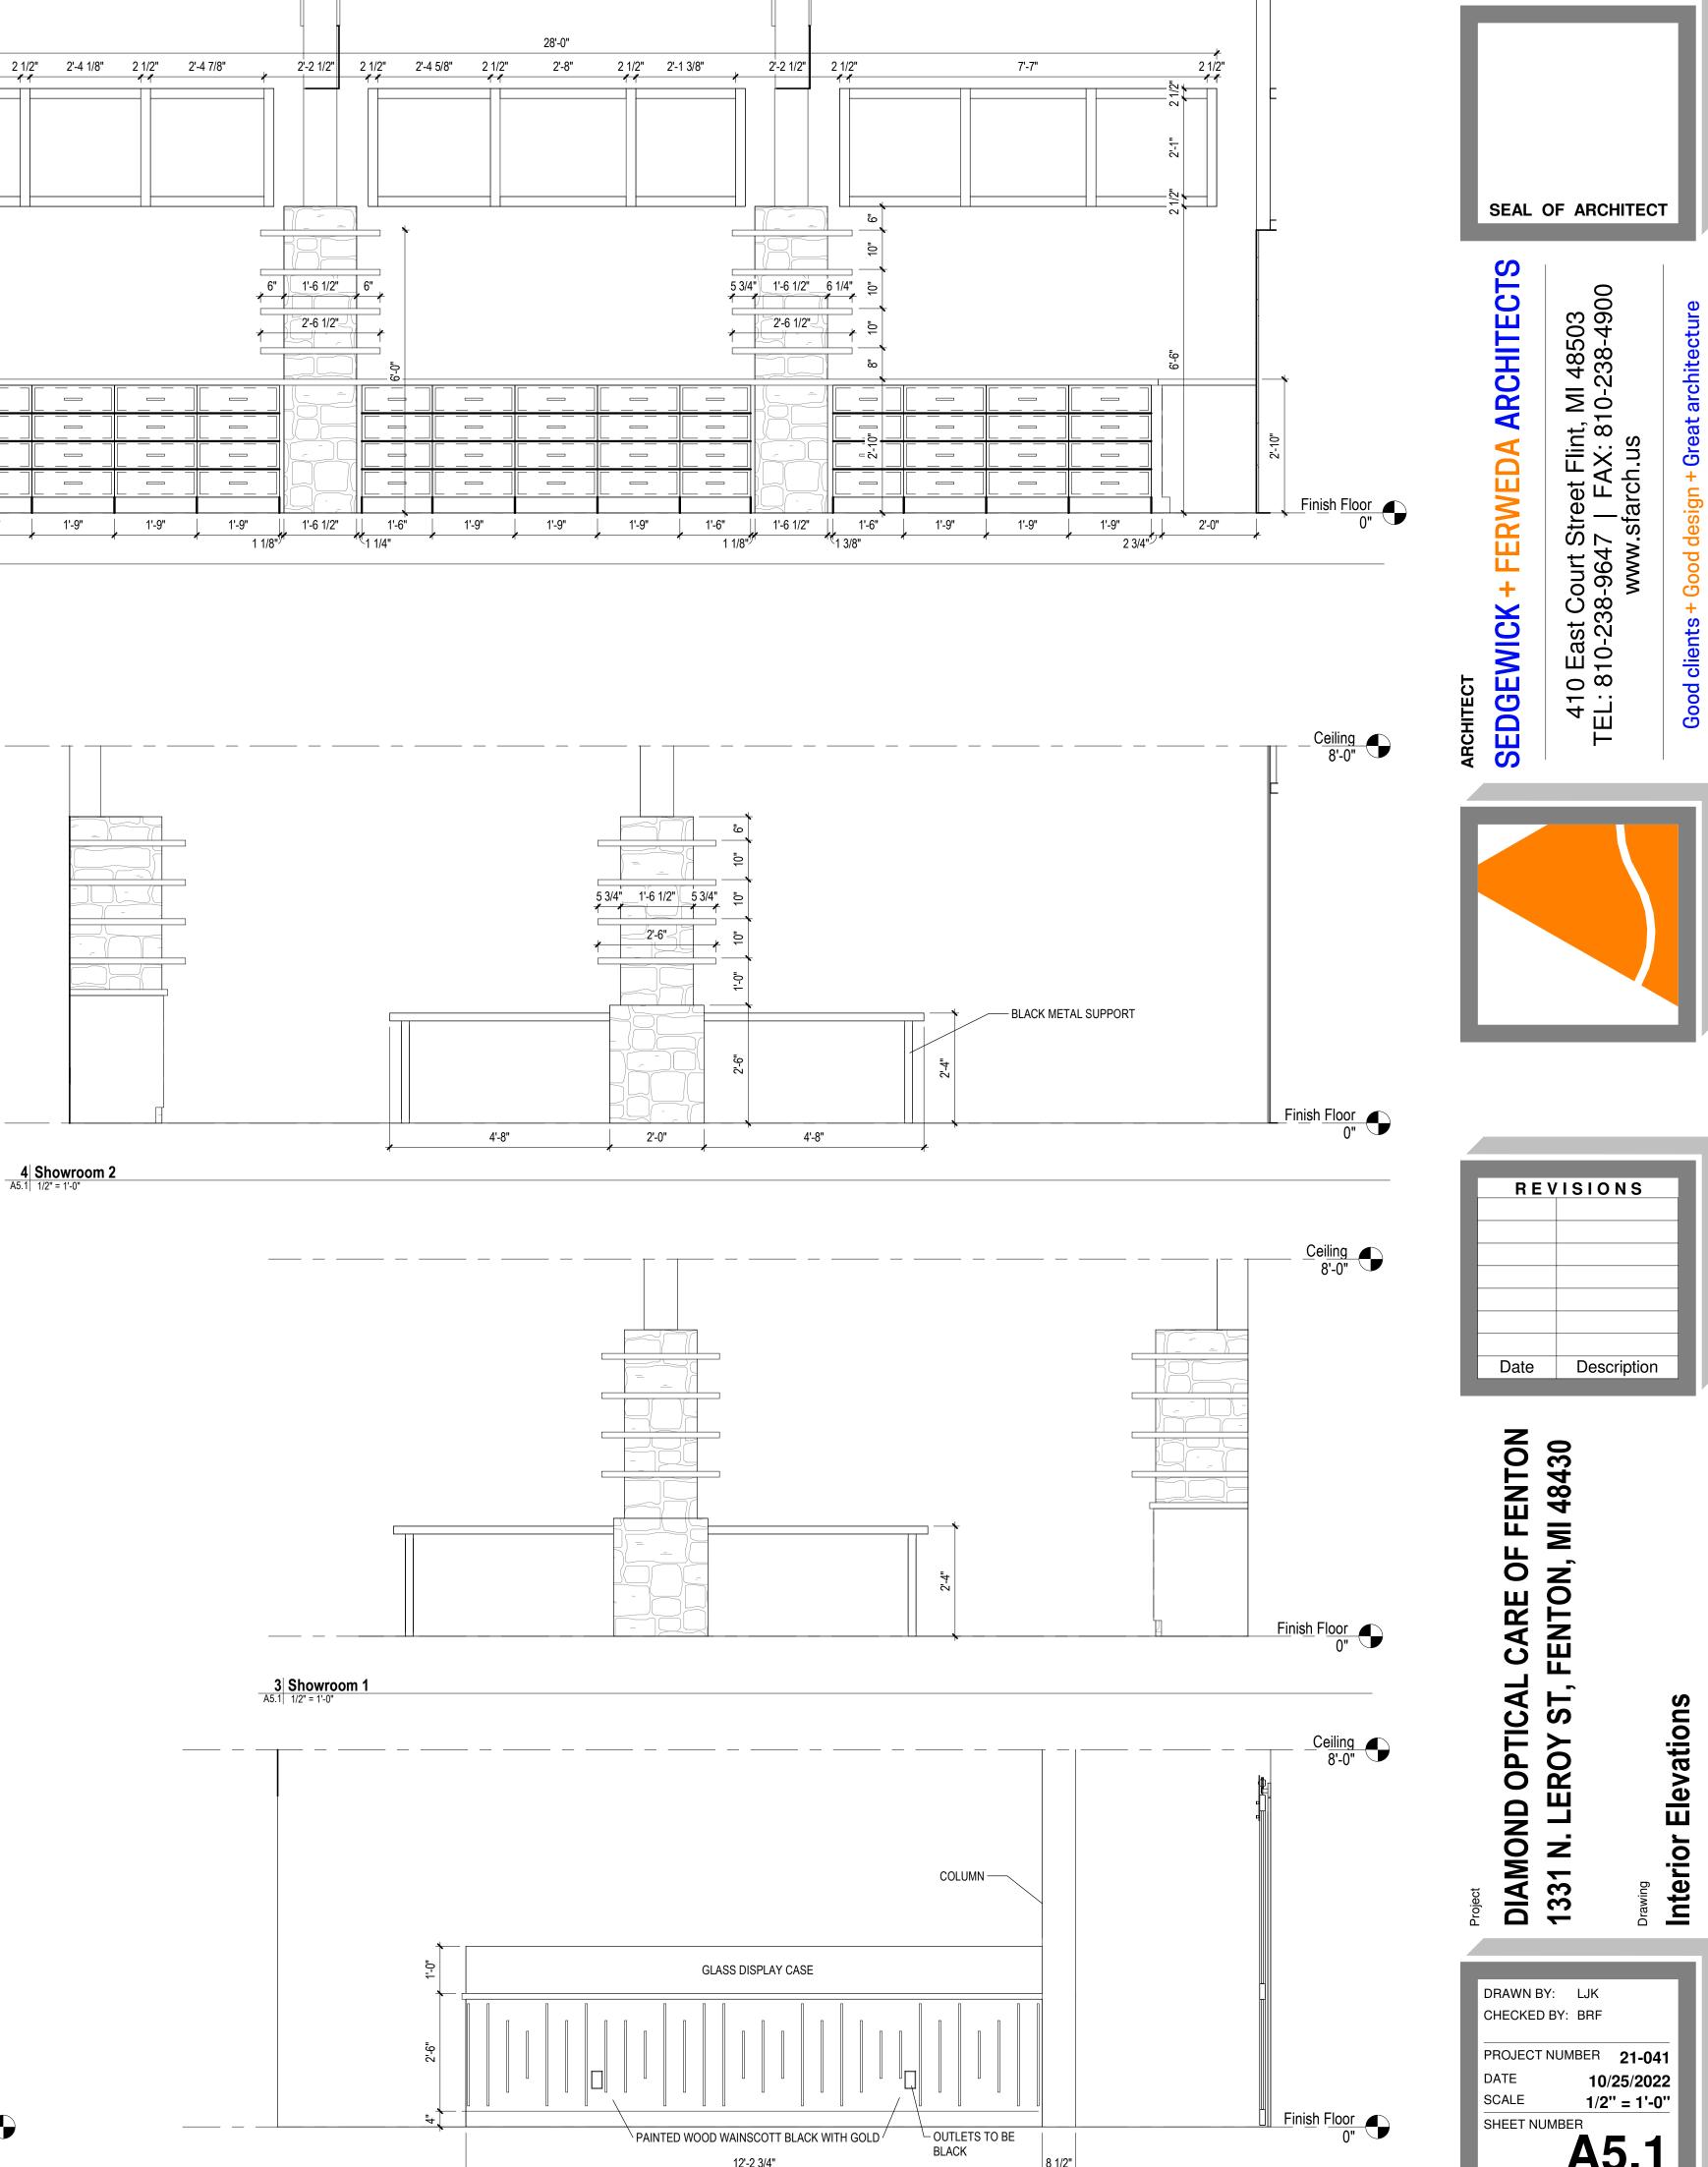


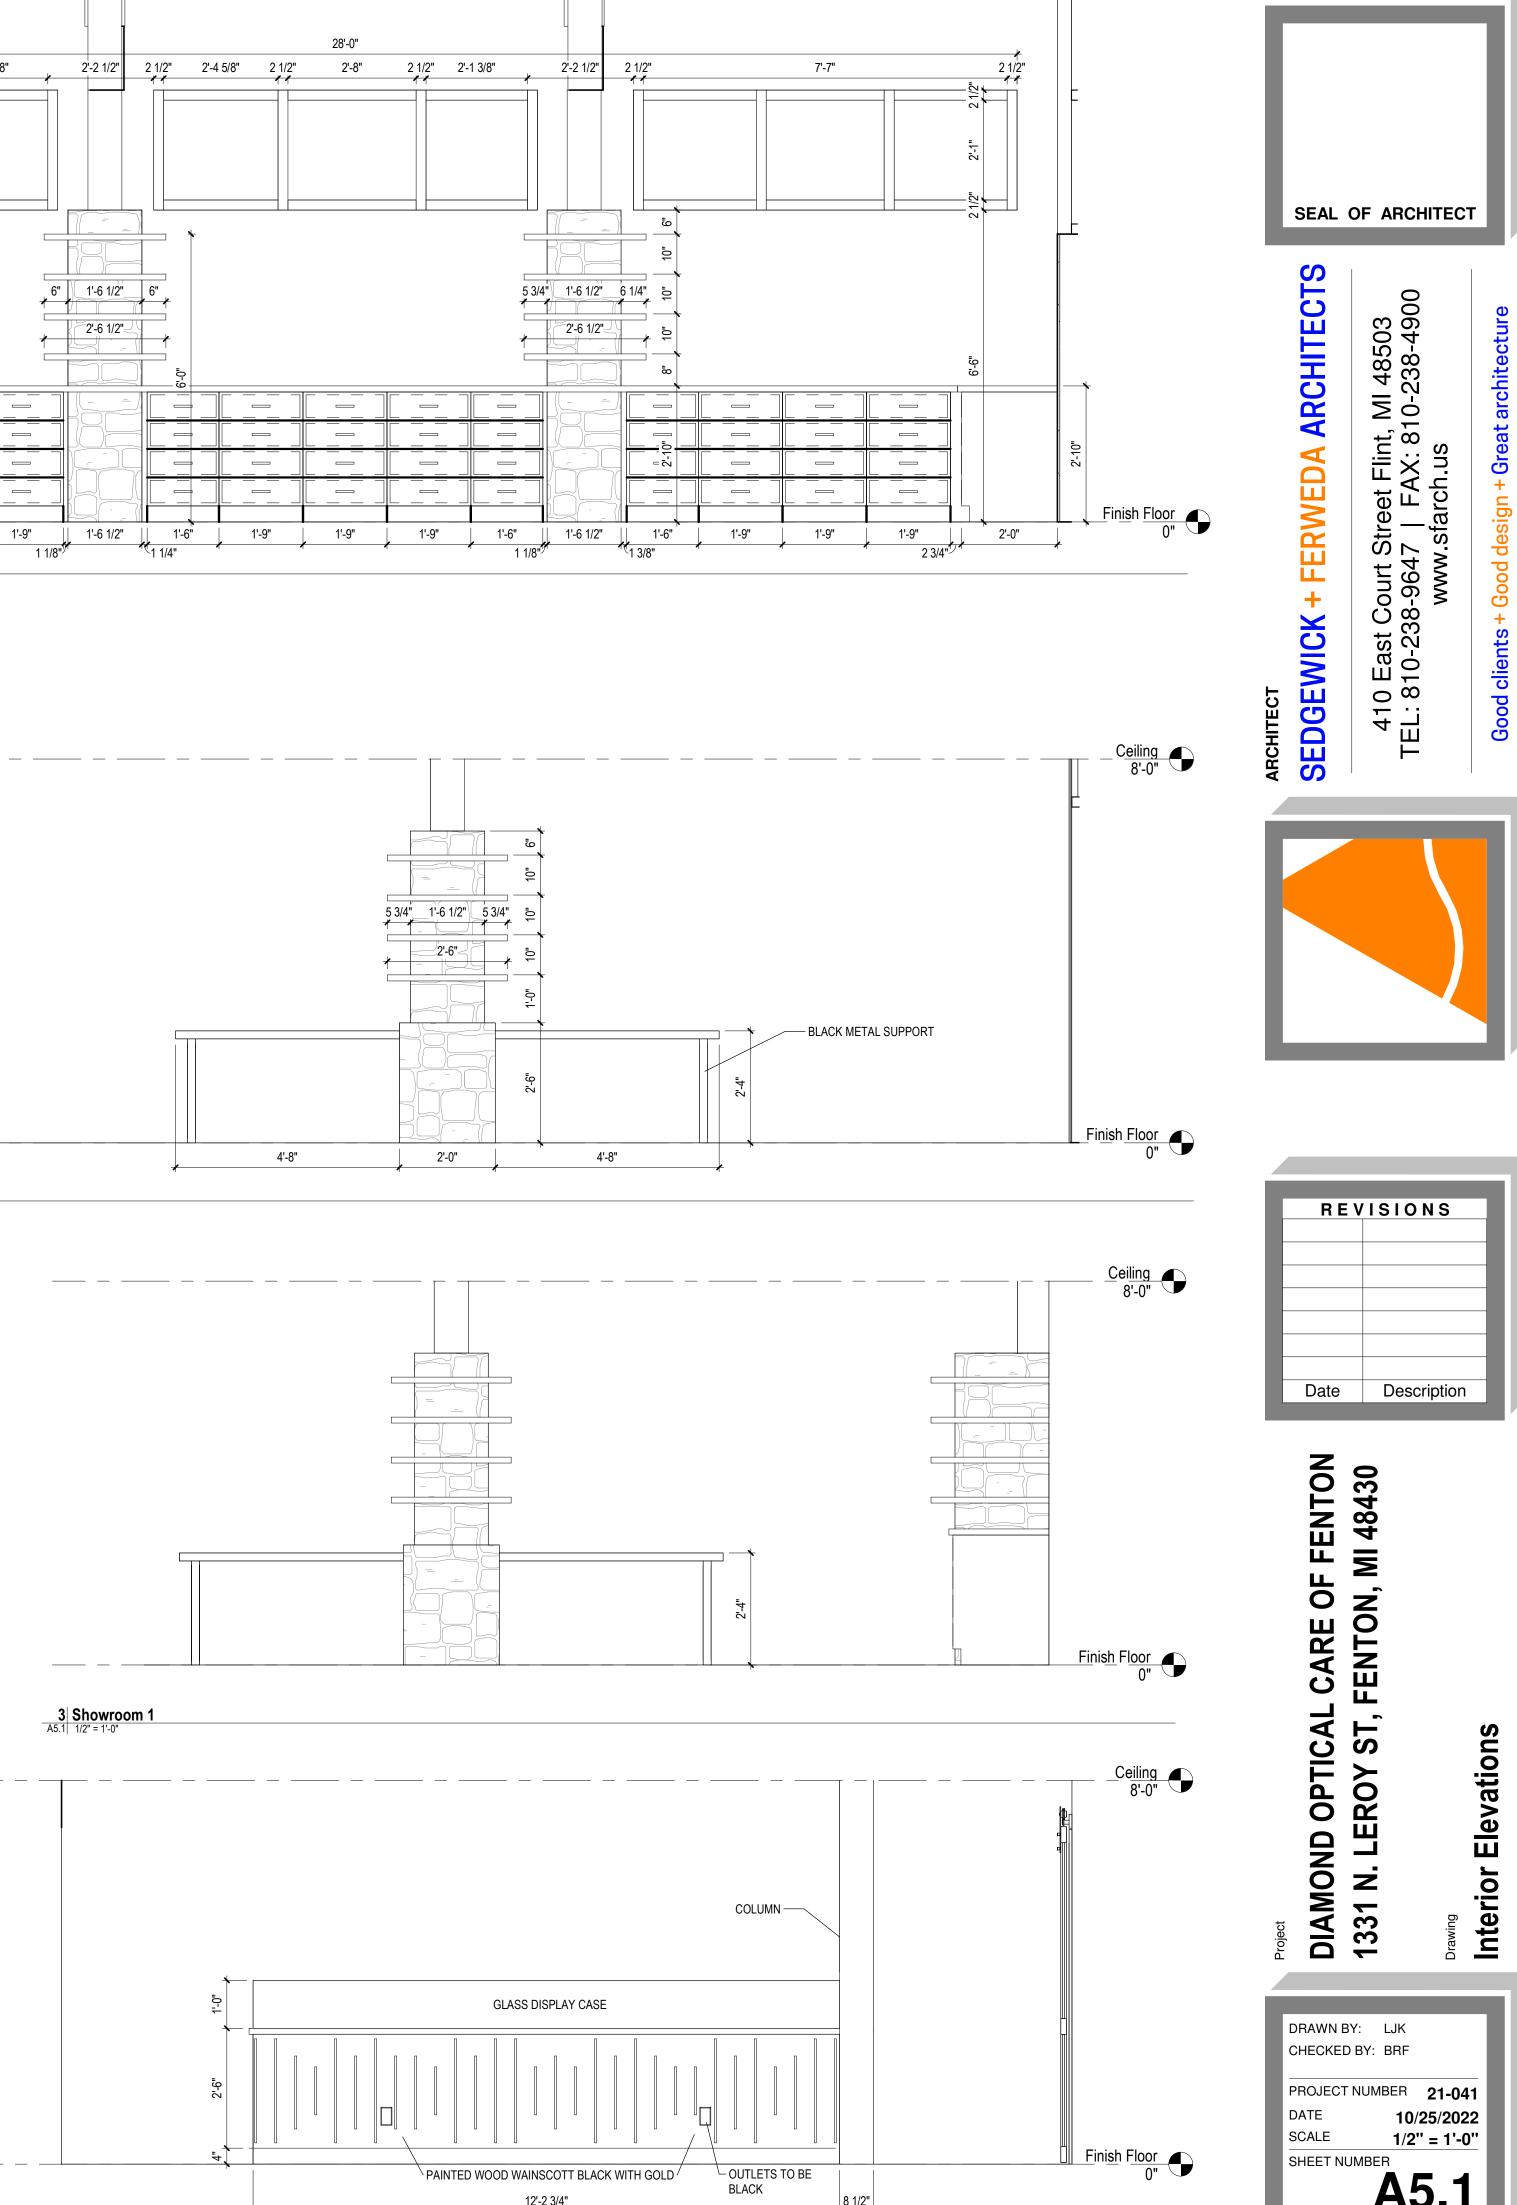


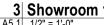


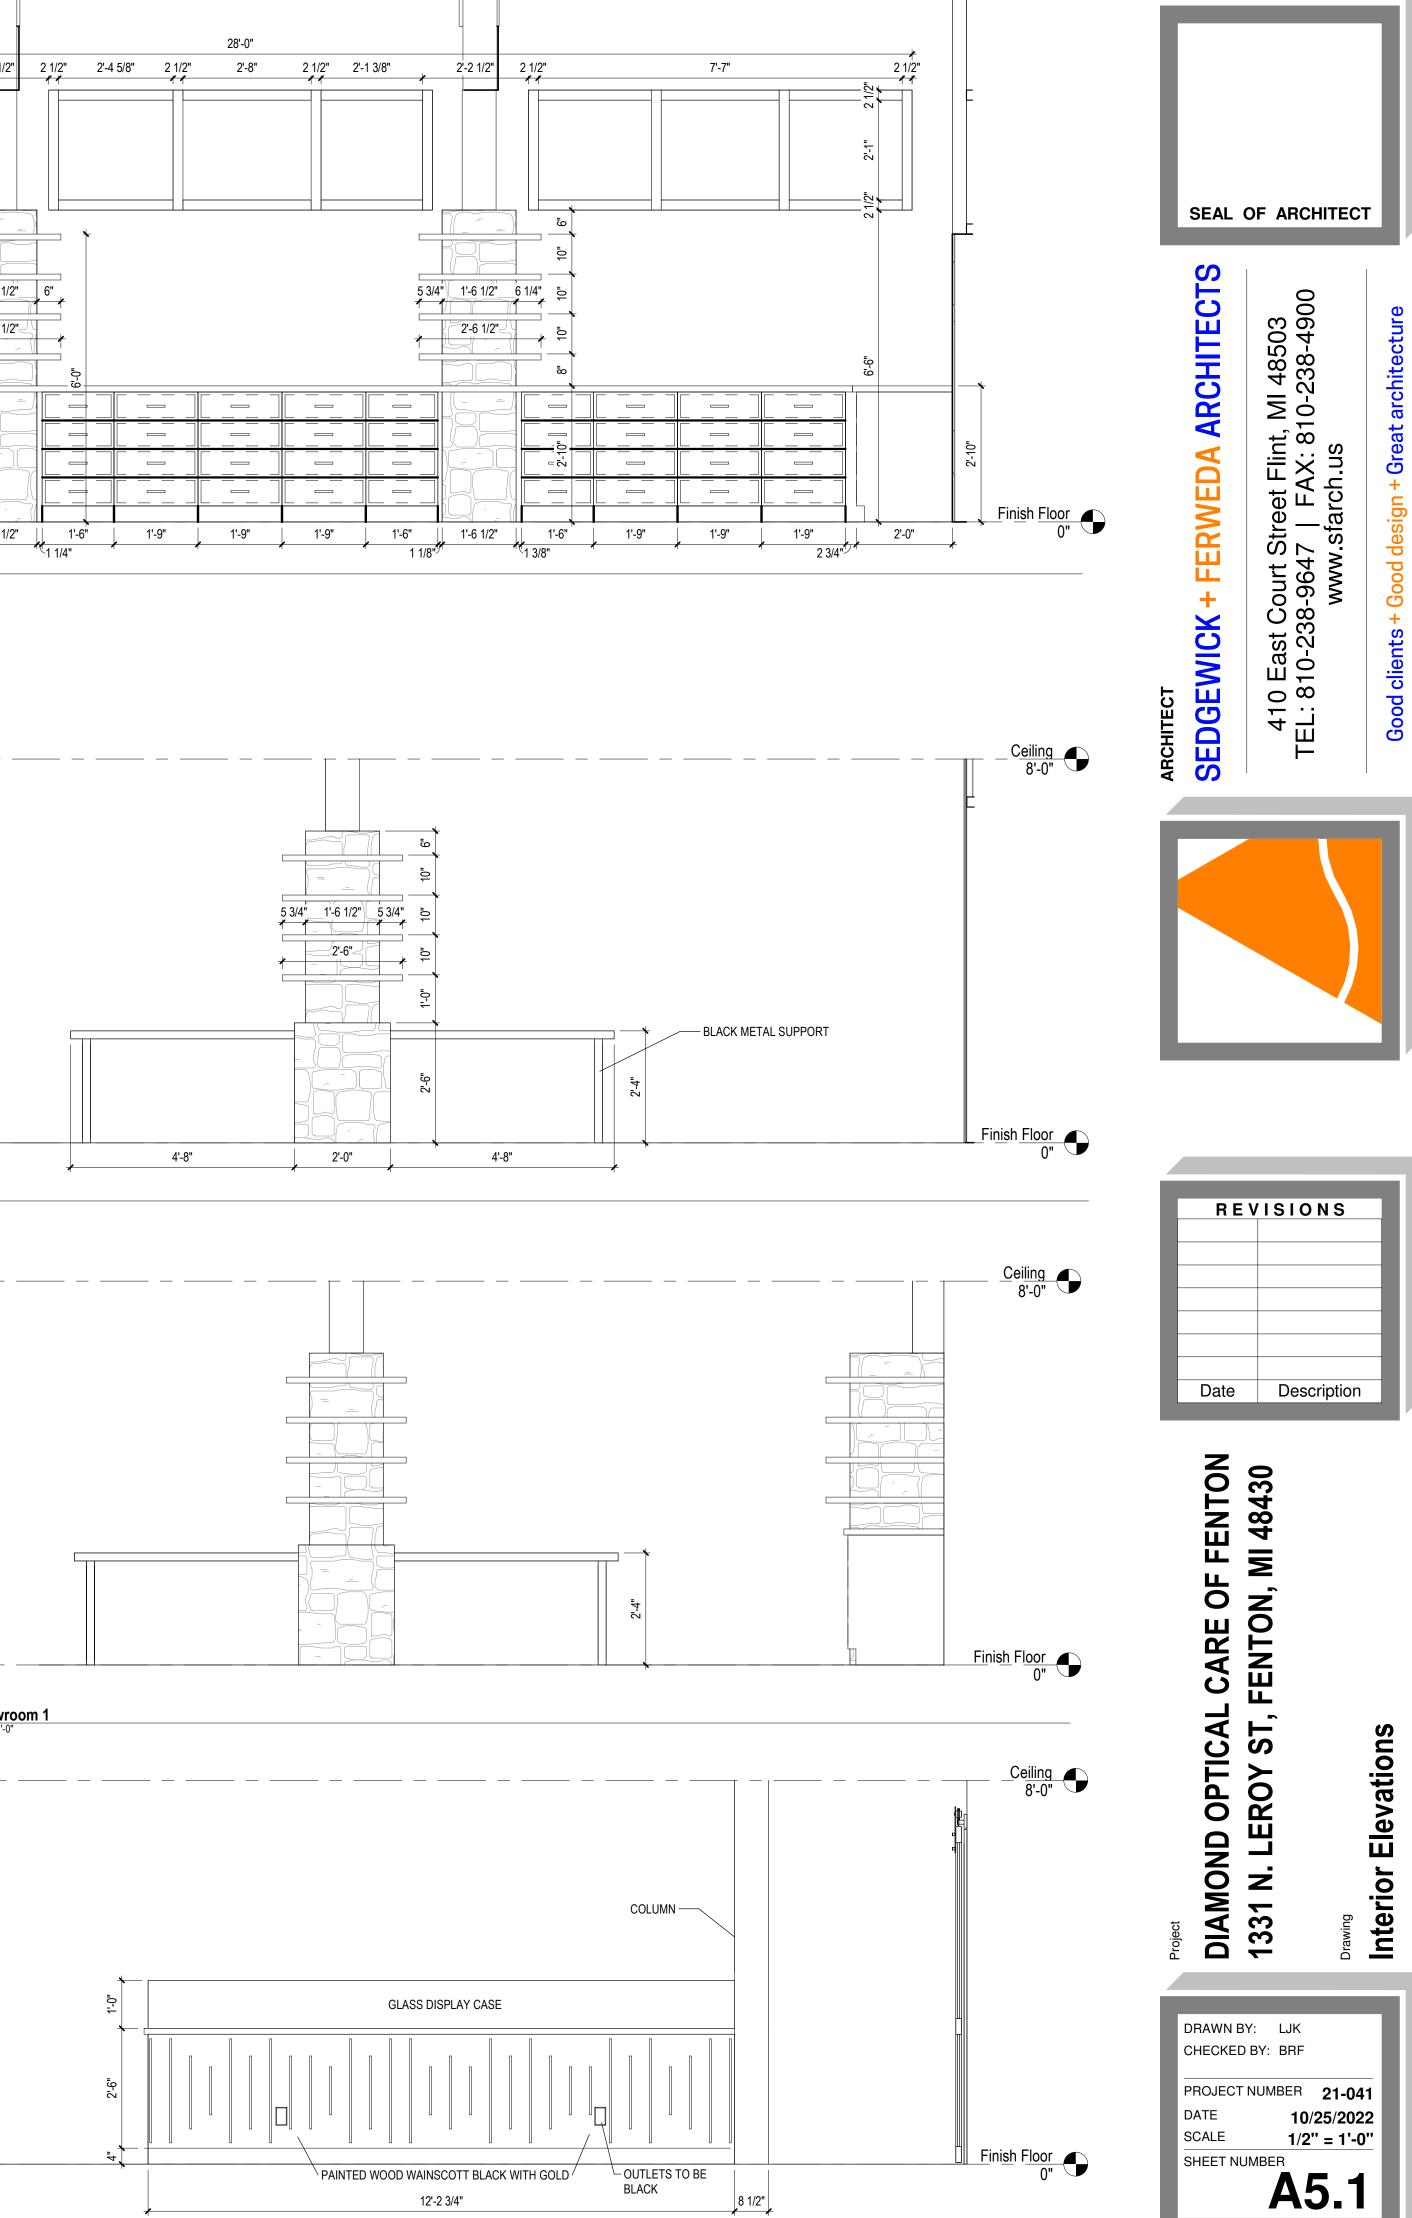




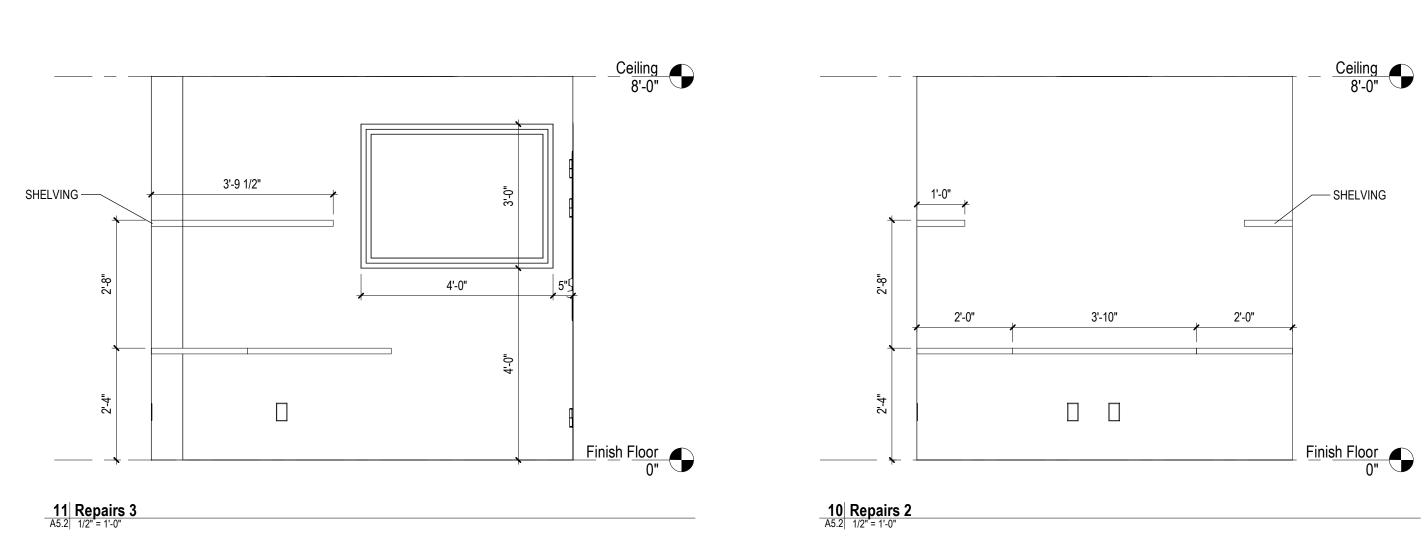

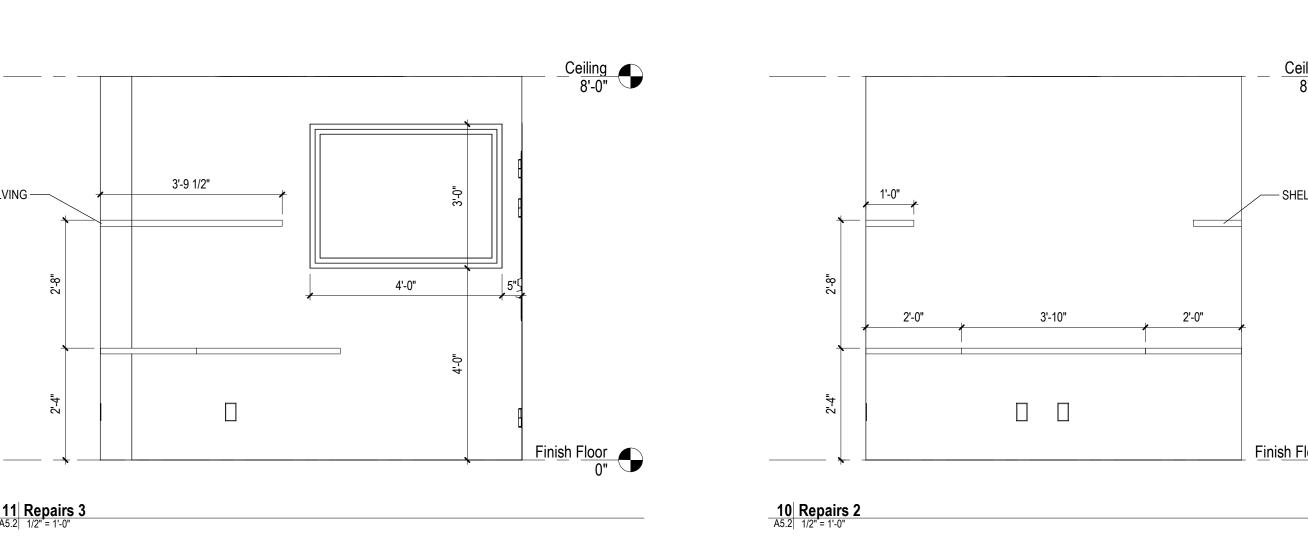


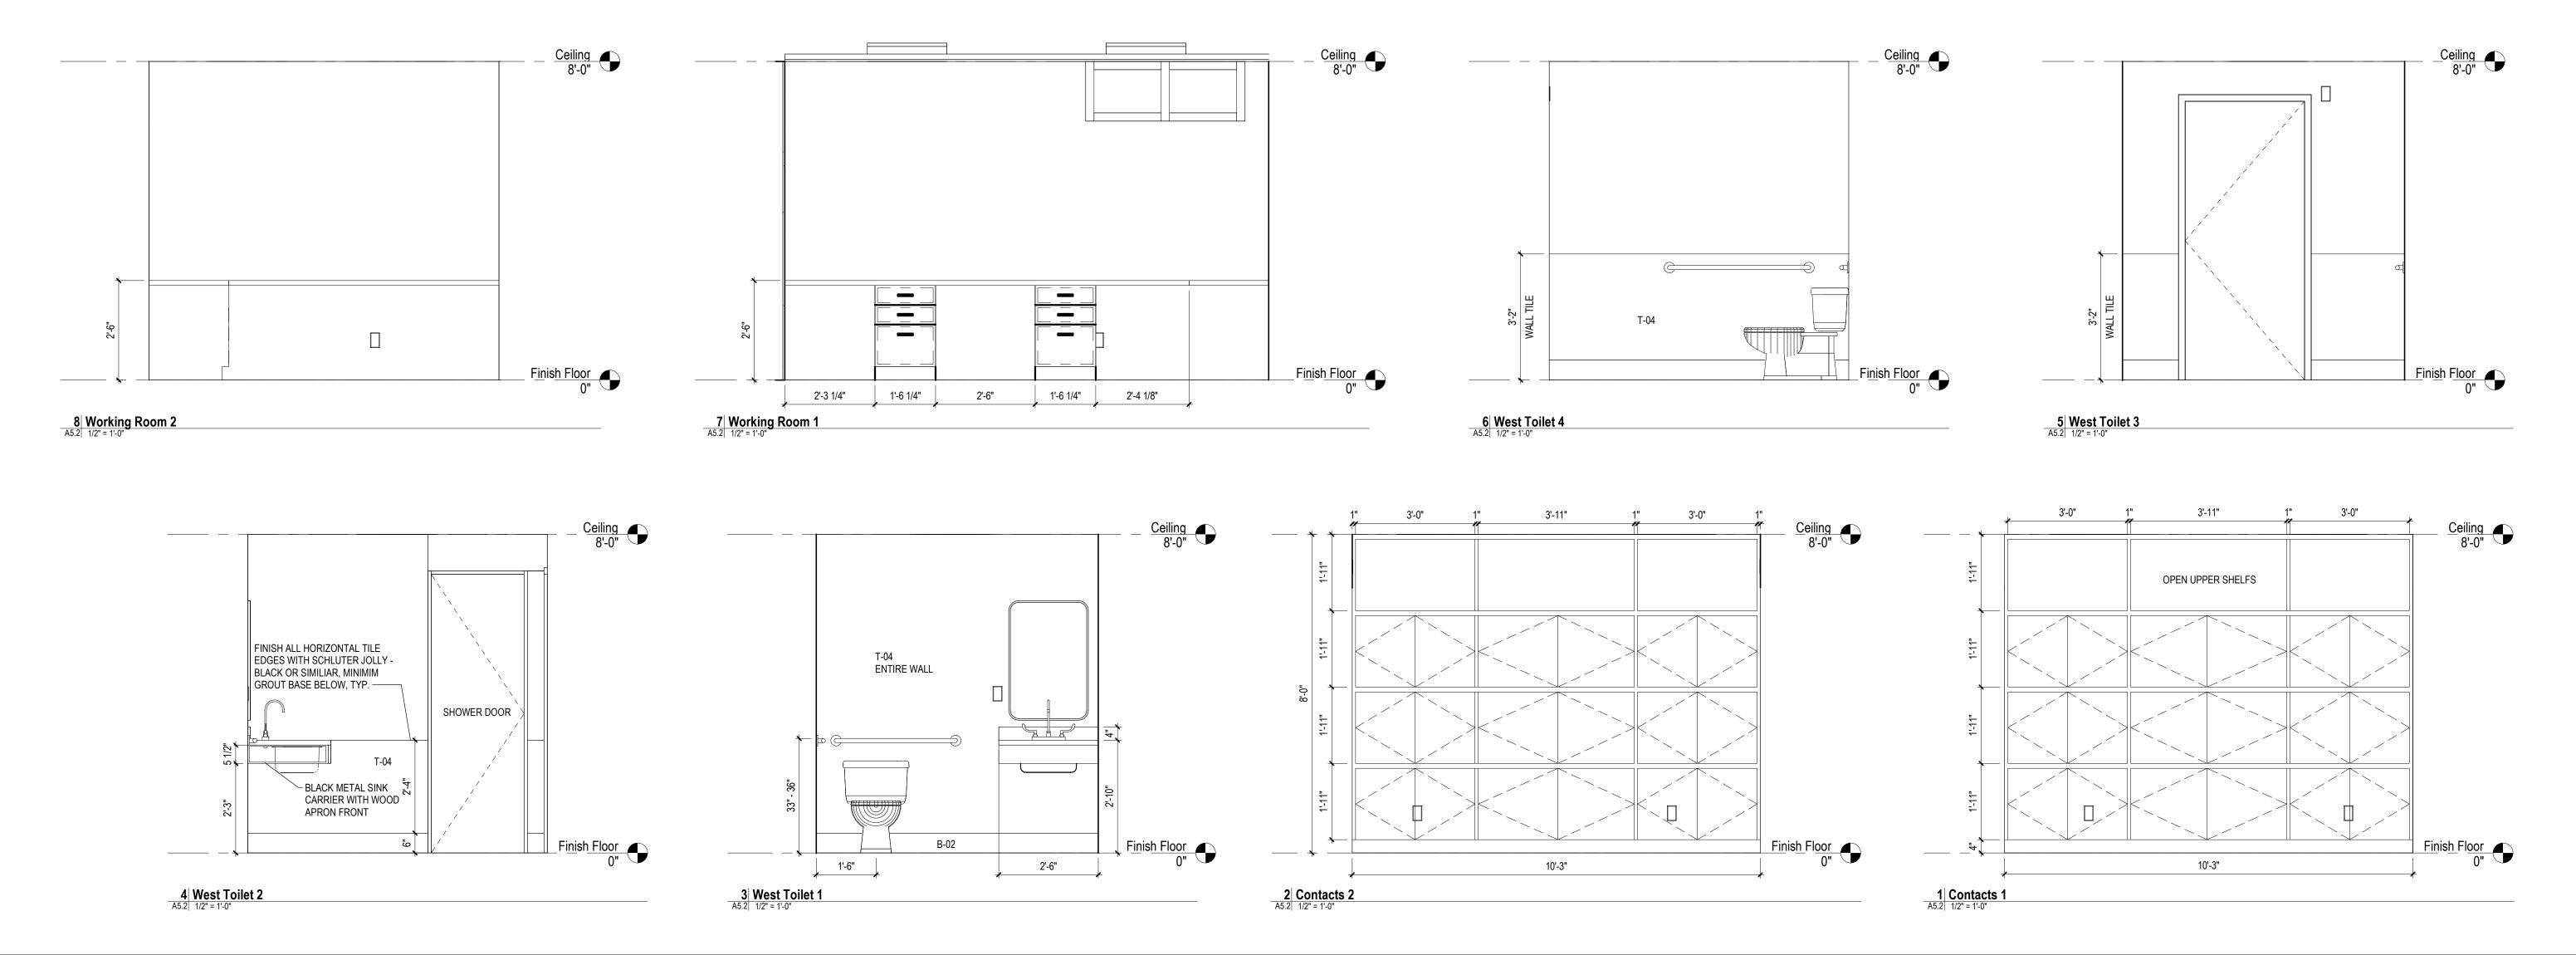



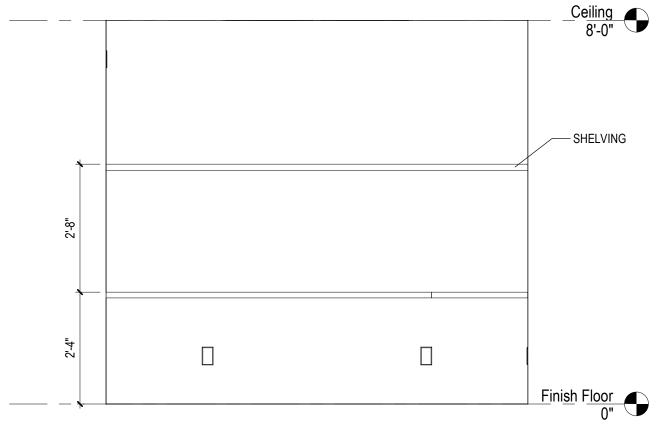



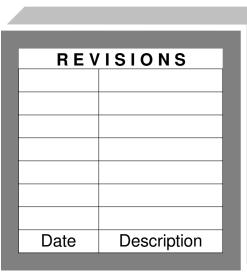




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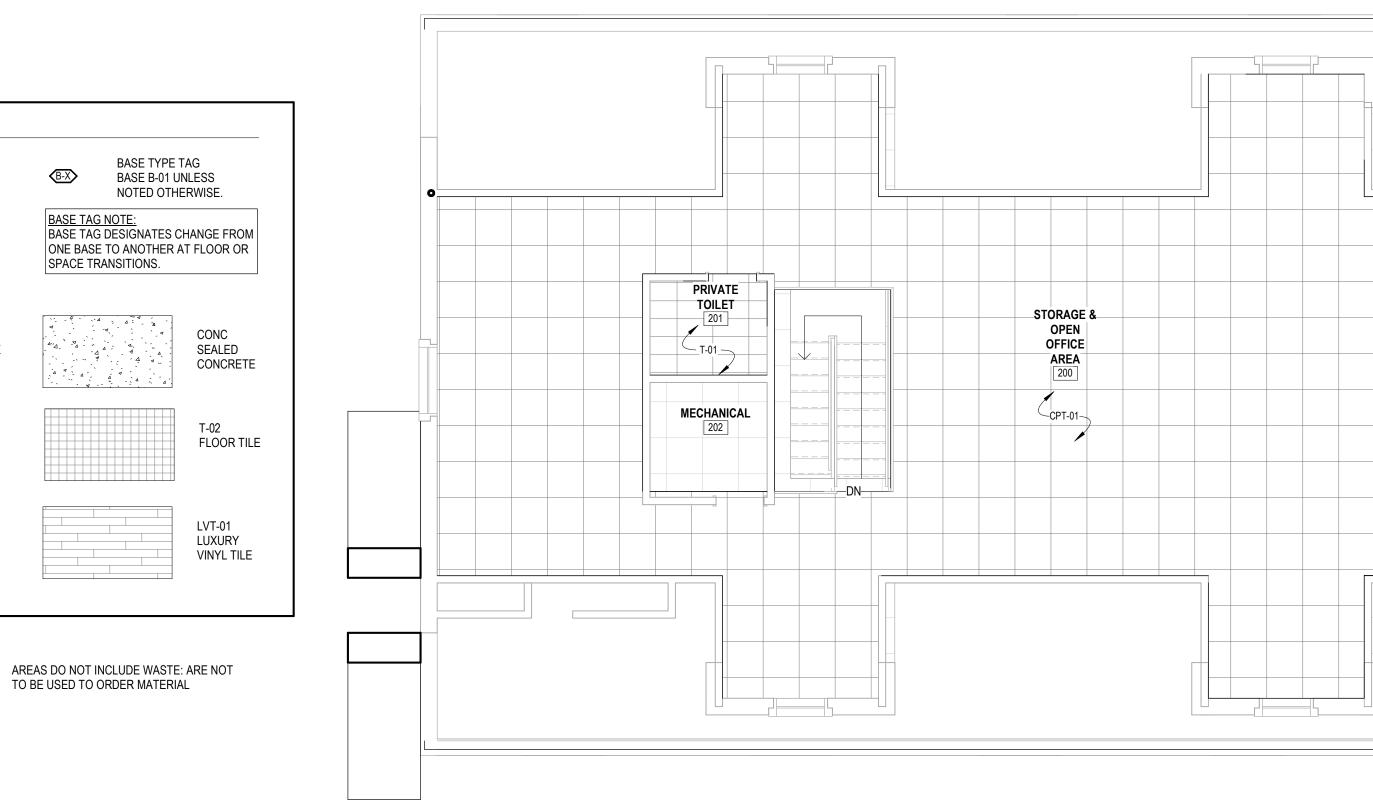
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112			THRESHOLD PER A.D.A. REQ.		
ENTRY THRESHOLD (ENTRY) TO ENTRY	ENTRY	C-02		FINISH PLAN LEGE	ND
CARPET TILE (C-02)					
			— SHEET VINYL (SV-01)	└── X-X ── FLO	OR FINISH TAG
			— JOHNSONITE #CTA-XX-H RUBBER TRANSITION STRIP COLOR: #47		
			"BROWN"	,	ORING
SHEET VINYL (SV-01)	TO		— CARPET (C-01)	IRA	NSITION TAG
CARPET (C-01)	SV-01	<u> </u>	CARFET (C-01)	P-02 WAL	L FINISH TAG
				/	
					CPT-01 CARPET TILE
SHEET VINYL (SV-01) LUXURY VINYL PLANK (LV-01)		LV-01	— LUXURY VINYL PLANK (LV-01)		
(2001)			— LUXURY VINYL PLANK (LV-01)		T 04
			— RESILIENT TRANSITION INSTALLED PRIOR TO CARPET INSTALL; REFER TO SPECS FOR COLOR		T-01 FLOOR TILE
LUXURY VINYL PLANK (LV-01) TO]
<u>CARPET (C-01)</u>	LV-01	<u>C-01</u>	 — SHEET VINYL (SV-01) — STAINLESS STEEL TRANSITION STRIP SCHLUTER 5/16" RENO-U 		T-03 FLOOR TILE
			— POUR FLOORING (RF-01) FLUSH TRANSITION STRIP VINYL FLOORING (SV-01)		
SHEET VINYL (SV-01)	<u>.</u>				
TO LIQUID-APPLIED RESINOUS FLOORING	<u>SV-01</u>	RF-01	(RF-01)		
<u>(RF-01)</u>			 SHEET VINYL (SV-01) INSTALLED FLUSH TO EDGE OF TRENCH DRAIN HOUSING EDGE OF TRENCH DRAIN HOUSING SET 	FLOOR MATERIAL 1	ſAKEOFF
			INTO SLAB	NAME	AREA
SHEET VINYL (SV-01)	ТО			LVT-01	594 SF
TRENCH DRAIN (TD-0	<u>1)</u> sv 01	TD-01		T-01	553 SF
	30-01			T-02	12 SF
			(RF-01) POURED TO EDGE OF TRENCH DRAIN HOUSING	T-03 Grand total: 11	30 SF 1189 SF
			EDGE OF TRENCH DRAIN HOUSING SET INTO SLAB		
<u>(RF-01) TO TRENCH</u> DRAIN (TD-01)	RF-01	TD-01			
		Υ <u></u>			

3 Flooring Transition Details

STANDARD FINISHES SCHEDULE	
LOORING	PAINT:
	P-01 FIELD COLOR
CARPET TILE:	SHERWIN WILLIAMS 'SW 6253' 'OLYMPUS WHITE'
	NO-VOC / EGG-SHELL
MOHAWK COLLECTION: OPTIC RESET	P-02 ACCENT COLOR
STYLE: FIELD OF VIEW - LIGHT - 12" X 36" PLANKS	9-02 ACCENT COLOR SHERWIN WILLIAMS 'SW 6255' MORNING FOG'
COLOR: 979 SILHOUETTE LIGHT	NO-VOC / EGG-SHELL
NSTALLATION: BRICK ASHLAR	NO-VOC/LOG-SHELL
NOTALLATION. DIVINI AGHLAN	P-03 DOOR FRAMES
LUXURY VINYL TILE:	SHERWIN WILLIAMS 'SW 6258' 'TRICORN BLACK'
LVT-01	LOW/NO-VOC / SEMI-GLOSS
DIVINE FLOORING	HOLLOW METAL DOOR/WINDOW FRAMES
STYLE: JOURNEY 7" X 48" PLANK 3/16" THICKNESS	
COLOR: MOONDANCE - OAK	ALL PAINT COLORS TO BE FEILD VERIFIED BY OWNER
	INCLUDING DRAW DOWNS
PORCELAIN FLOOR TILE:	
T-01	COUNTERTOPS:
ATLAS CONCORD	CT-01
SERIES: OUTLAND 12X24	WILSONART SOLID SURFACE
COLOR: DARK	COLOR: MORNING ICE
BATHROOM TILE - HERRINGBONE LAYOUT	07.00
OTHER AREAS - BRICK ASHLAR	
T 00	
	COLOR: ONYX CARRARA
ATLAS CONCORD SERIES: OUTLAND MOSAIC 2X2	SPECIFIC LOCATION: RECEPTION DESK AND BACK COUNTER
COLOR: DARK	WALL TILE
ODEON. DANK	
T-03	T-04
ATLAS CONCORD	INTERCERAMIC
SERIES: EON 12X24	COLLECTION: WALL TILE
COLOR: CORINTHIAN GRAY	3X6 SUBWAY TILE
GENESEE TILE:	ACOUSTIC CEILING SYSTEMS:
CONTACT BILL KOHN	ACT-01 CEILING TILE
989-205-6600	ARMSTRONG "CIRRUS" SQUARE LAY-IN 24" X 24" X 7/8"
BKOHN@GCTILE.COM	WHITE
	70 NRC / 40 CAC
SEALED CONCRETE:	PRELUDE 15/16" GRID (WHITE)
CONC DUR-A-FLEX DUR-A-SHIELD	
COLOR: CLEAR	<u>CABINETS</u>
CONTACT: DUR-A-FLEX, REFER TO SECTION 6: FBO	
	WELLBORN CABINETS - PREMIER SERIES
BASE:	OWNER TO APPROVE FINISHES
ROPPE RUBBER BASE CONTOURS	CABINET HARDWARE TO BE BLACK
COLOR - SMOKE	
CONTOUR PROFILE - SIMPLICITY 4" BASE	
B-02 ATLAS CONCORD	
SERIES: OUTLAND COVE BASE 6X12	
COLOR: DARK	

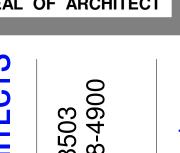





B-X

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2 Second Floor Finish Plan A6.1 3/16" = 1'-0"




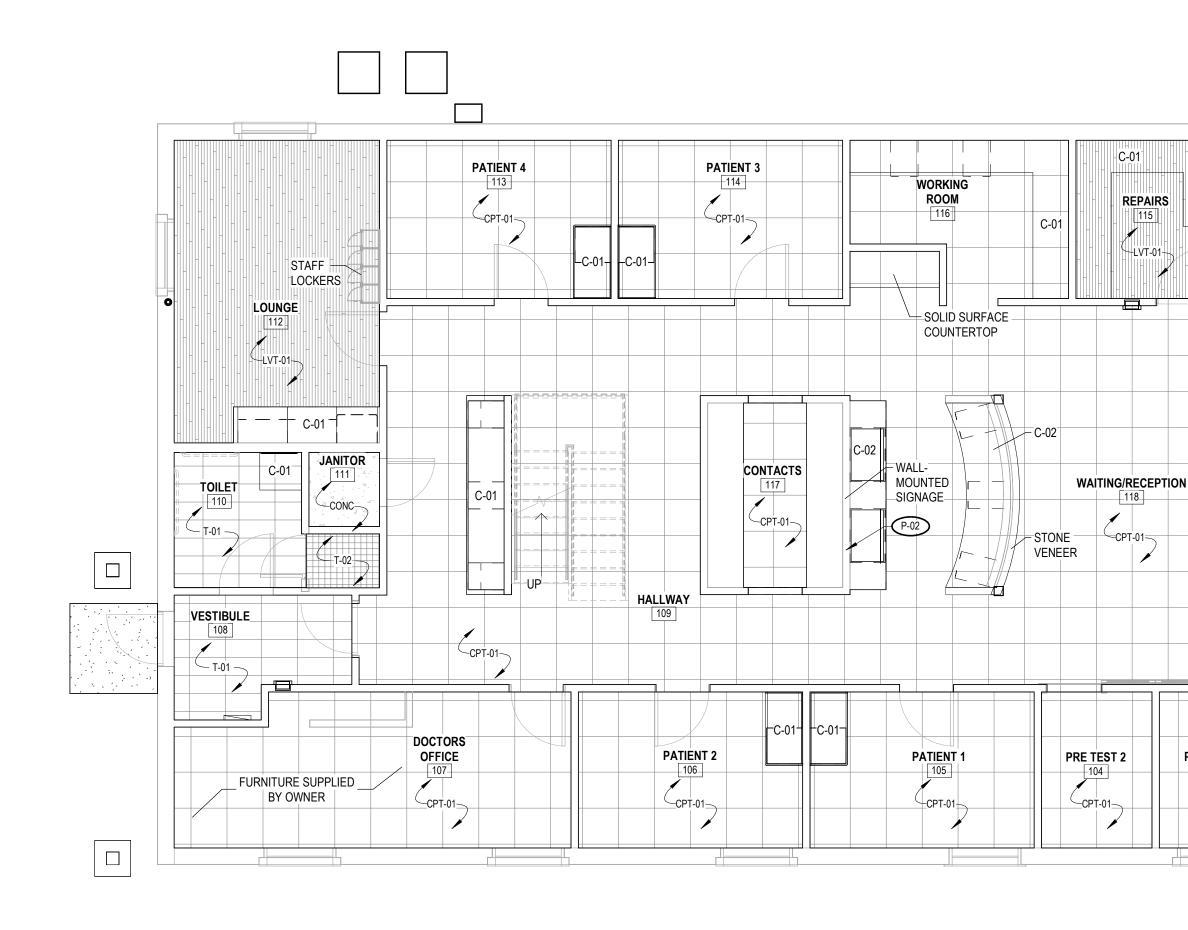




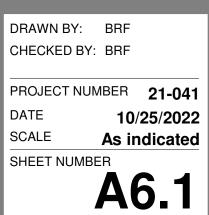



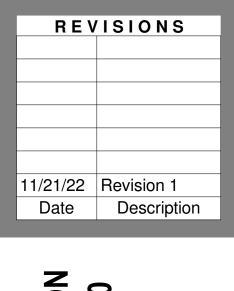

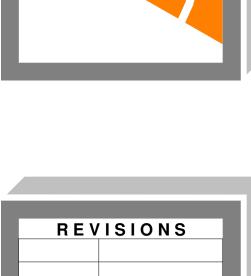



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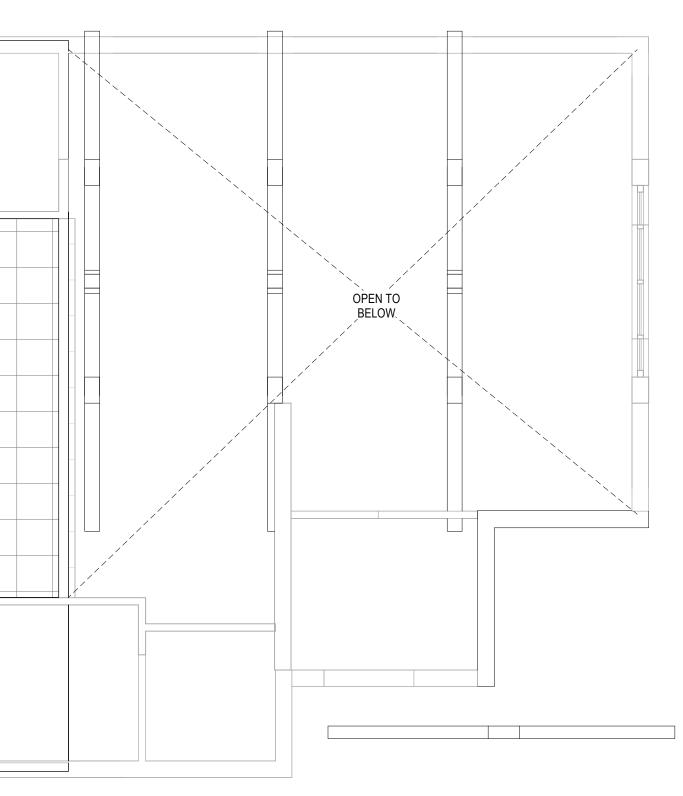
CHITECT

SEAL OF ARCHITECT

5

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C-01

____STONE VENEER___

LVT FLOORING - PROVIDE

BACKING TO LIFT FLOORING TO THE SAME LEVEL AS T-01, NO C-01 TRANSITION STRIP

SHOWROOM

101

REQUIERED

Ч——————————— `

C-01

C-01

C-01

PRE TEST 1

103

C-01 102

← T-01 —

WT-01 ALL

WALLS

C-01

C-01

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C-01

VESTIBULE-

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4 Elevation 3 - a A8.0 1/4" = 1'-0"


PLASTIC 'J' CHANNELS TO FINISH EDGE OF GYP BRD CAULK TO DECKING AND SASH FRAMING —

1/2" CLEAR PINE SHEATHING OVER 2X4 STUD FRAMING FROM UNDERSIDE OF WD DECKING TO ALUM STOREFRONT GLAZING FILL CAVITY WITH RIGID EXTRUDED POLYSTYRENE INSULATION


1" CORIAN WINDOW SILL -


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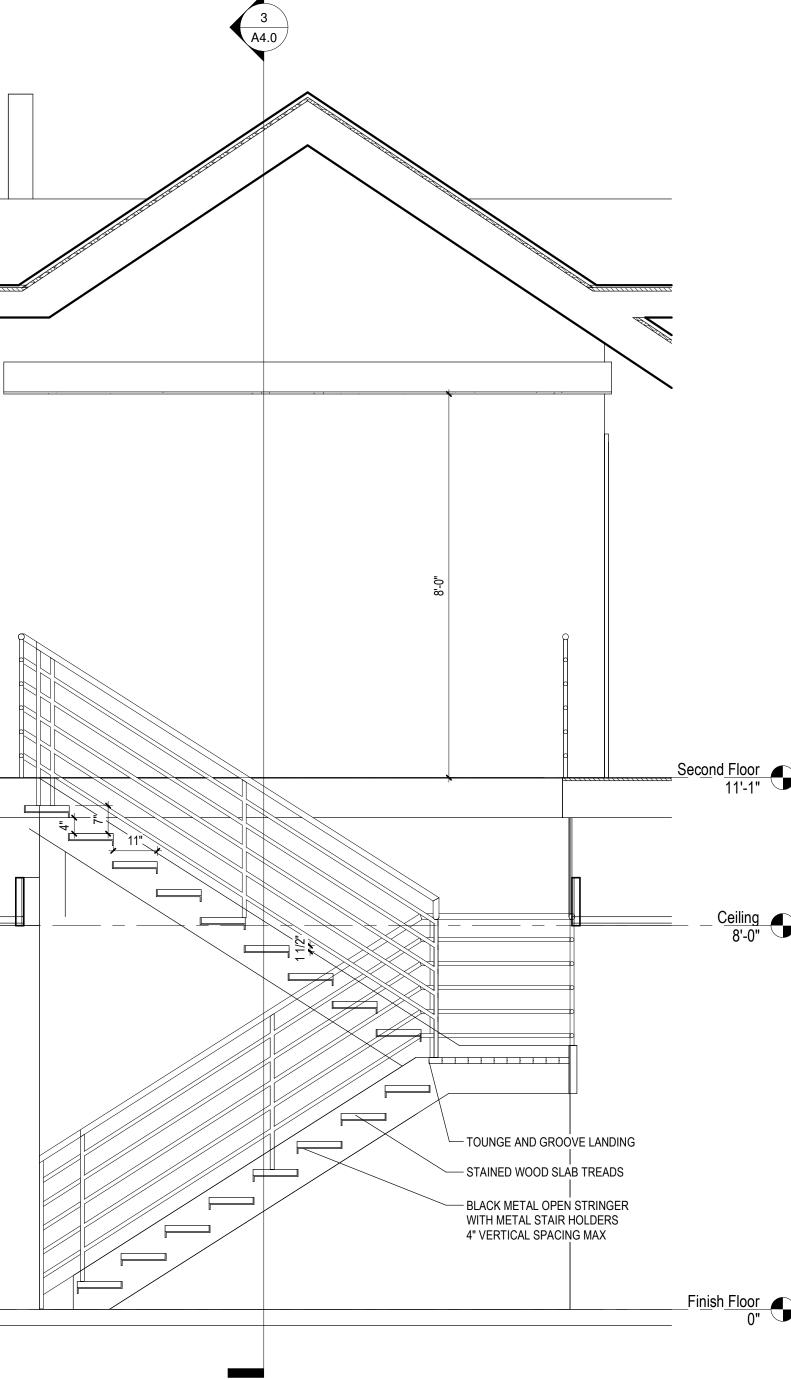
3 Section 2 A8.0 3/4" = 1'-0"




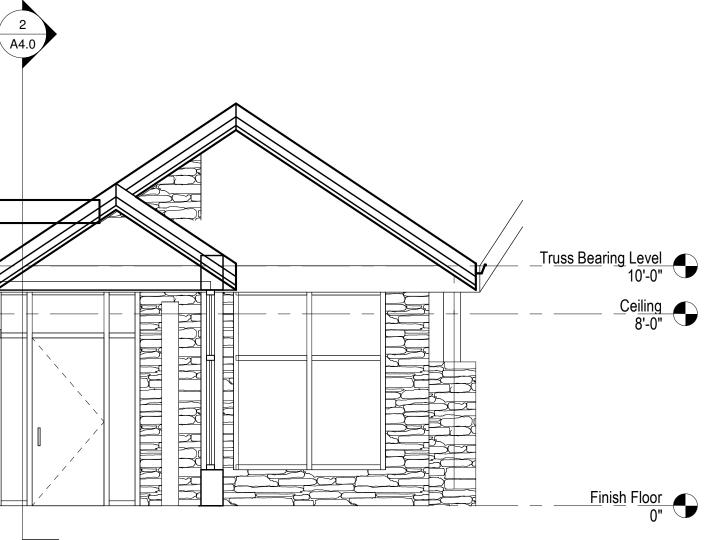



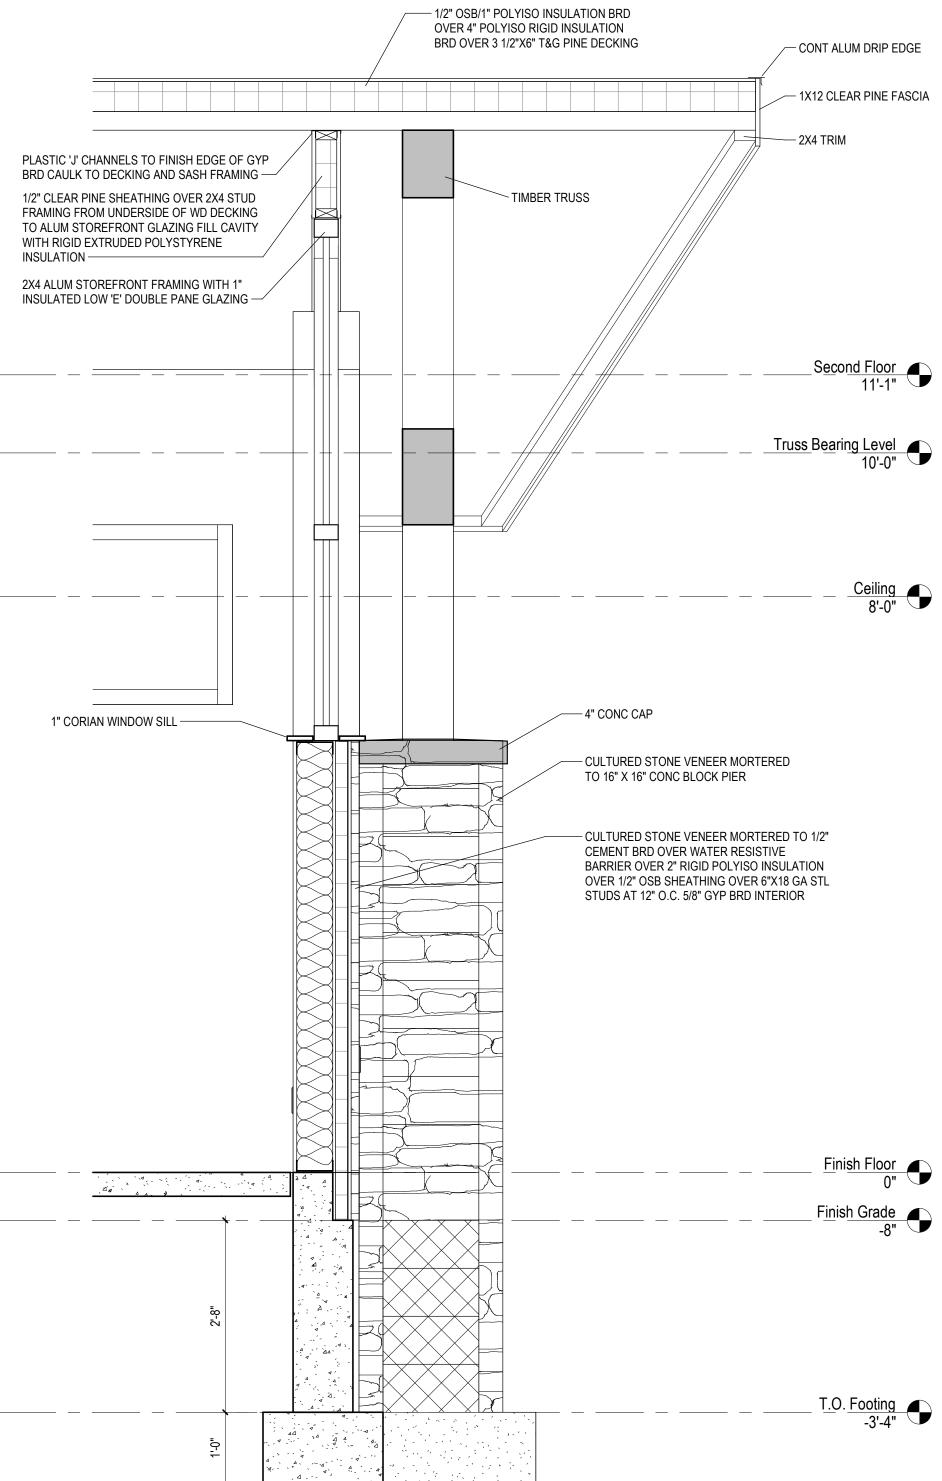

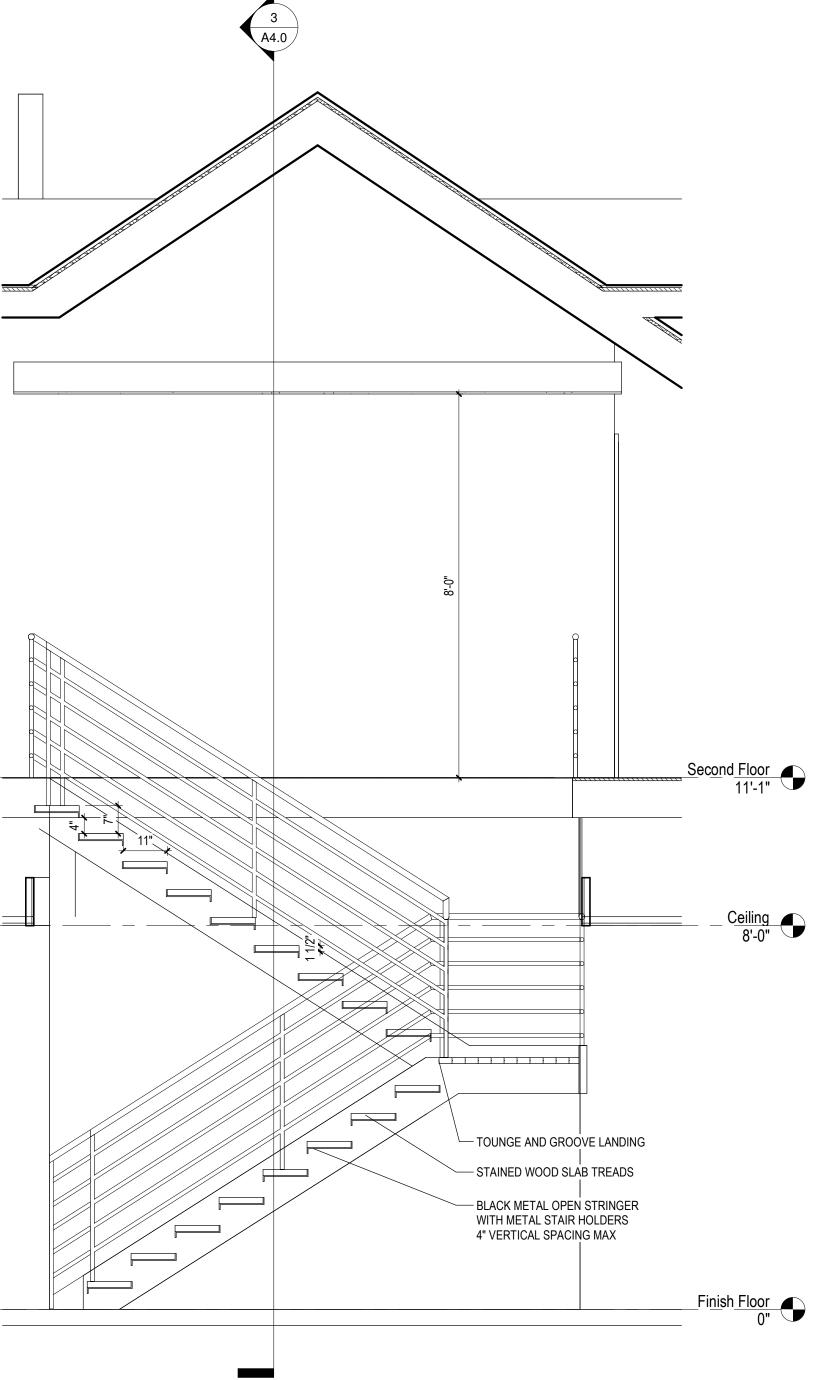

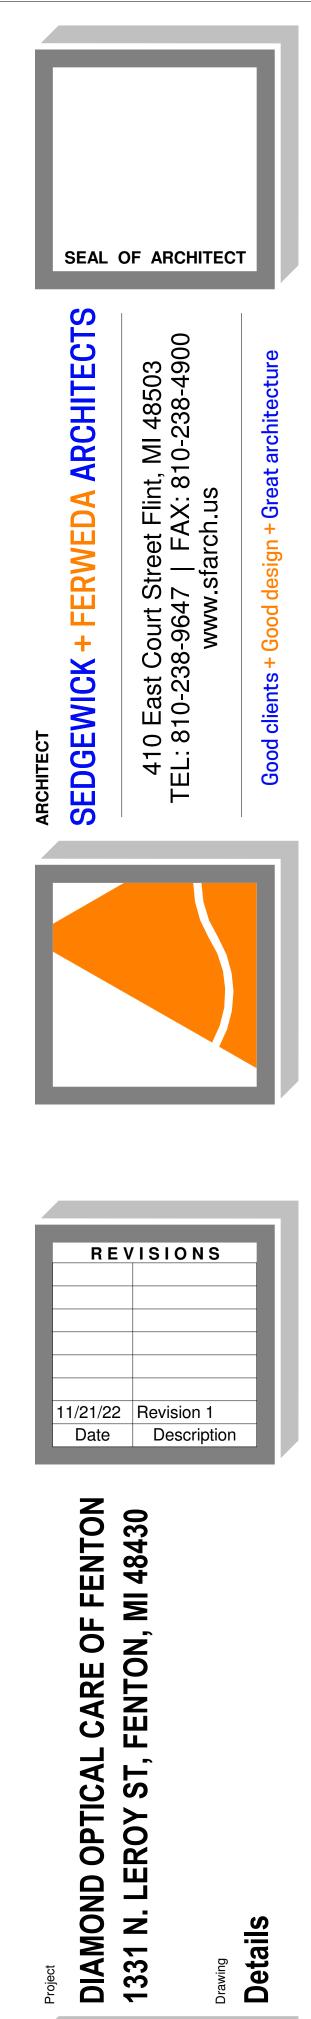

DRAWN BY: LJK

SHEET NUMBER

DATE SCALE

CHECKED BY: MJM

PROJECT NUMBER 21-041

10/25/2022

As indicated

A8.0

PLUMBING NOTES:

SCOPE	
1.	THE WORK TO BE PERFORMED UNDER THE PLUMBING PLANS AND SPECIFICATIONS CONSISTS OF FURNISHINGS ALL MATERIAL AND LABOR FOR THE
	COMPLETE INSTALLATION FOR ALL PLUMBING SYSTEMS FOR TENANT SPACES. THE WORK SHALL INCLUDE BUT NOT LIMITED TO THE FOLLOWINGS:
	A. COLD AND HOT WATER SYSTEMS
	B. DRAINAGE AND VENT SYSTEMS
	C. INSULATION
	D. GAS PIPING
2.	CONTRACTOR SHALL COORDINATE ALL WORK WITH OTHER TRADE TO AVOID CONFLICT AND TO FACILITATE THE WORK WITHOUT CAUSING UNNECESSARY
	DELAYS. IMMEDIATELY REPORT ANY DISCREPANCIES, IN WRITING, TO THE ENGINEER. ALL CHANGES AND/OR ALTERATIONS REQUIRE REVIEW AND
	APPROVAL BY THE ENGINEER.
3.	CONTRACTOR SHALL COORDINATE WITH EQUIPMENT VENDOR AND PROVIDE FOR ALL PIPING, VALVES, CONNECTIONS, ETC. AS INDICATED.
GENER	RAL
1.	ALL WORK IS TO BE PERFORMED IN STRICT COMPLIANCE WITH THE LATEST EDITION OF THE NATIONAL STANDARD PLUMBING CODE, MPC-2015, ALL LOCAL
	CODES, AND ALL OTHER REGULATION GOVERNING WORK OF THIS NATURE.
2.	THE CONTRACTOR IS RESPONSIBLE FOR ALL WORK MATERIALS AND LABOR TO SATISFY A COMPLETE AND WORKING SYSTEM WHETHER SPECIFIED OR
	IMPLIED.
3.	DO NOT SCALE THIS DRAWING FOR EXACT DIMENSIONS. VERIFY ALL FIGURES, CONDITIONS, DIMENSIONS, ETC. AT THE JOB SITE.
4.	LOCATIONS OF EXISTING EQUIPMENT, PIPING, VENTS, ETC. HAVE BEEN TAKEN FROM BEST AVAILABLE INFORMATION. THE DRAWINGS ARE INTENDED TO BE
	USED FOR INFORMATIONAL PURPOSES ONLY. THE CONTRACTOR IS NOT TO SCALE DRAWINGS OR ASSUME THAT ALL COMPONENTS ARE SHOWN. HE SHALL
	VISIT THE SITE TO DETERMINE THE TOTAL EXTENT OF REMOVALS AND NEW WORK AS DIAGRAMMED ON THE PLANS. EXTRA COMPENSATIONS FOR FAILURE
	TO COMPLY WITH THE ABOVE STATEMENT WILL NOT BE CONSIDERED.
5.	THE CONTRACTOR SHALL COORDINATE ALL WORK WITH A COMPLETE SET OF M/P/E ARCHITECTURAL, AND EQUIPMENT VENDOR DESIGN DRAWINGS IF
	APPLICABLE. IMMEDIATELY REPORT ANY DISCREPANCIES TO THE ENGINEERS OFFICE.
6.	THE CONTRACTOR SHALL SECURE ALL PERMITS OR APPLICATIONS AND PAY ANY AND ALL FEES REQUIRED.
7	ALL DELIMBING FLYTHRES SHALL RE SEDARATELY VALVED

- ALL PLUMBING FIXTURES SHALL BE SEPARATELY VALVED ALL WATER BRANCHES AND RISERS SHALL BE SEPARATELY VALVED.
- CONTRACTOR SHALL MAKE ALL PLUMBING CONNECTIONS REQUIRED TO EQUIPMENT SUPPLIED BY OTHERS.
- CONTRACTOR SHALL PROVIDE AND INSTALL ALL HOT AND COLD WATER CONNECTIONS TO THE PLUMBING FIXTURES. CONTRACTOR SHALL COORDINATE WITH GENERAL CONTRACTOR FOR THE INSTALLATION OF METAL ACCESS DOORS BY MILCOR STYLE "DW" (NON FIRE 11 RATED) OR STYLE "UFR" (1 1/2 HOUR FIRE RATED) AT ALL LOCATIONS REQUIRED TO ACCESS VALVES, DEVICES, ETC. CONCEALED ABOVE CEILINGS OR IN WALLS
- CONTRACTOR SHALL PROVIDE WATER HAMMER ARRESTORS ON APPLIANCES/FIXTURES THAT HAVE FAST CLOSING VALVES. APPLIANC 12. INCLUDE BUT NOT NECESSARILY LIMITED TO CLOTHES WASHER, DISH WASHER, SELF CLOSING VALVES, PULSATING SHOWER HEADS, E CONTRACTOR SHALL PROVIDE FOR SAW CUTTING, EXCAVATION, BACKFILL AND RESTORATION TO MATCH EXISTING CONDITIONS AS NE 13
- PROPERLY EXECUTING THE PLUMBING SCOPE OF WORK. REFRIGERANT PIPING FOR A/C CONDENSER TO BE FURNISHED BY MANUFACTURER AND INSTALLED BY CONTRACTOR. INSULATE LIQUID 14
- LINES WITH 1" ARMAFLEX ALL PLUMBING FIXTURES ROUGH IN AND INSTALLATION AS PER MICHIGAN BUILDING CODE 2015 AND THE AMERICAN DISABILITY ACT.
- ALL VENTS TERMINATING ABOVE ROOF SHALL BE 25 FT HORIZONTALLY AWAY FROM AIR INTAKES. CONTRACTOR TO CONTACT LOCAL GAS, WATER, AND SEWAGE DEPARTMENTS AND MAKE APPLICATION FOR NEW SERVICE AND NOTIFY OWNER OR 17 PROVIDE UTILITY FEES TO BRING SERVICE TO THE BUILDING
- DEMOLITION

CONTRACTOR IS RESPONSIBLE FOR SELECTIVE DEMOLITION IN ALL AREAS AS REQUIRED TO ACCOMMODATE THE PROJECTS SCOPE OF WORK. ALL SYSTEMS AND ANCILLARY COMPONENTS MADE OBSOLETE SHALL BE COMPLETELY REMOVED AND DISPOSED. INSTALL BY-PASS WHERE REQUIRED TO MAINTAIN THE INTEGRITY OF OVERALL SYSTEMS REMAINING AND SERVING AREAS OUTSIDE THE SCOPE OF WORK AREA.

CONTRACTOR SHALL PERFORM A SITE INSPECTION TO ESTABLISH EXTENT OF DEMOLITION PRIOR TO BID. <u>SUBSTITUTES</u>

SUBSTITUTES AND "OR EQUAL" SUBMISSION MUST BE APPROVED IN WRITING BY ENGINEER PRIOR TO SUBMISSION OF BID.

IDENTIFICATIONS PROVIDE STENCILED PIPE MARKERS OR PLASTIC TAPE WITH COLOR COMPLYING WITH ANSI A13.1 INCLUDE DIRECTION OF FLOW. LOCATE MARKERS NEAR VALVES, EACH BRANCH TAKE OFF AND NEAR MAJOR EQUIPMENT. MAXIMUM SPACE INTERVALS SHALL NOT EXCEED 50'-0".

SOIL WASTE AND VENT PIPING

- SOIL WASTE PIPING AND FITTINGS SHALL BE ABS, SCHEDULE 40 DWV (ASTM D2661).
- VENT PIPING AND FITTINGS SHALL BE ABS, SCHEDULE 40 DWV (ASTM D2661). ALL VENT PIPING SHALL HAVE A MINIMUM SLOPE OF 1/4" PER FOOT AND SHALL DRAIN TO FIXTURES.
- ALL WASTE PIPING SHALL SLOPE AS FOLLOWS:
- 3" AND SMALLER SHALL HAVE A SLOPE OF 1/4" PER FOOT
- 4" AND LARGER SHALL HAVE A SLOPE OF 1/8" PER FOOT PROVIDE EXTRA DEEP TRAP WITH "SURE SEAL" INLINE FLOOR DRAIN TRAP SEALERS ON ALL FLOOR DRAINS AND FLOOR SINKS.
- SUPPORT PIPING AT MAXIMUM 4'-0" INTERVALS.
- WATER PIPING

DOMESTIC WATER PIPING SHALL BE TYPE "L" COPPER TUBING ABOVE GROUND OR TYPE "K" BELOW GROUND WITH SOLDERED JOINTS USING LEAD FREE SOLDER, PROPERLY CLEANED, USING AN APPROVED FLUX.

- SUPPORT PIPING AT MAXIMUM 5'-0" INTERVALS FOR PIPING UP TO 2" AND AT 8'-0" INTERVALS FOR 2 1/2" AND UP. DOMESTIC HOT WATER TEMPERATURES SHALL BE AS FOLLOWS:
- PUBLIC HAND WASHING FACILITIES 120°F
- SINKS 120°F
- SERVICE/MOP SINKS 120°F PROVIDE LEONARD POINT OF USE THERMOSTATIC MIXING VALVES MODEL 270-LF OR EQUAL AT MAXIMUM SET POINT OF 105°F AS FOLLOWS: 4. IN PUBLIC TOILET ROOMS
- WASH FOUNTAINS WASH SINKS
- NATURAL GAS PIPING
- BLACK STEEL, SCH 40, ASTM A-120, WITH MALLEABLE IRON THREADED FITTING
- GAS PIPING TO BE PAINTED AND LABELED
- MATERIALS AND INSTALLATION AS PER MPC-2015 AND IFGC-2015 (INTERNATIONAL FUEL GAS CODE) INSULATION
- ALL HOT AND COLD WATER PIPING TO BE INSULATED WITH A MINIMUM OF 1" FIBERGLASS JACKETED INSULATION (ASTM C547, CLASS 1) WITH A FLAME SPREAD RATING OF 25 AND SMOKE DEVELOPED RATING OF 50.
- **ESCUTCHEONS** ALL EXPOSED PIPING EXCEPT AS OTHERWISE DESCRIBED PASSING THROUGH WALLS, FLOORS, CEILING, ETC. IN FINISHED SPACES SHALL BE PROVIDED WITH SOLID PATTERN BRASS CHROME PLATED ESCUTCHEONS WITH SET SCREW.
- BARRIER FREE REQUIREMENT ALL EXPOSED WASTE AND WATER PIPING WITHIN A BARRIER FREE BATHROOM SHALL BE INSULATED WITH A PRODUCT EQUAL TO IPS CORP. "TRUEBRO" LAV GUARD 2 UNDERSINK PROTECTIVE PIPE COVERS WITH INTERNAL, EZ TEAR-TO-FIT TRIM FEATURE FOR SQUARE CLEAN TRIMMING, INTERNAL RIBS AND BUILT-IN, CONCEALED E-Z GRIP FASTENERS (NO CABLE TIE FASTENERS ALLOWED).
- <u>FIRESTOP</u> PENETRATIONS FOR CABLES, CABLETRAYS, CONDUITS, PIPES, TUBES, COMBUSTION VENTS, AND EXHAUST VENTS, WIRES, AND SIMILAR ITEMS TO ACCOMMODATE ELECTRICAL, MECHANICAL, PLUMBING, AND COMMUNICATIONS SYSTEMS THAT PASS THROUGH A WALL, FLOOR, OR FLOOR/CEILING
- ASSEMBLY CONSTRUCTED AS A FIRE BARRIER SHALL BE PROTECTED BY A ACCORDANCE WITH ASTM E 814 OR ANSI / UL 1479. FLUSHING AND DISINFECTING POTABLE WATER SYSTEMS PRIOR TO BEING PLACED INTO SERVICE, ALL POTABLE WATER SYSTEMS SHALL BE FLUSHED AND DISINFECTED IN ACCORDANCE WITH MPC 2015,
- SECTION 610 "DISINFECTING POTABLE WATER SYSTEMS". TESTING
- CONTRACTOR SHALL PERFORM THE FOLLOWING TESTS IN ACCORDANCE WITH MPC 2015 SECTION 312 "TEST AND INSPECTIONS": DRAINAGE AND VENT SYSTEMS - SECTION 312.2 OR 312.3
- **BUILDING SEWER SECTION 312.6**
- WATER SUPPLY SYSTEMS SECTION 312.5
- BACKFLOW PREVENTERS SECTION 310.10 D.

ABBREVIATIONS

RS

RTU

ROOFTOP UNIT

					INICAL LEG
AD AFF ASR BDD CA CI CO CU CONN CVB EAG EWC EWH FD FLR FD FLR FS FTFD LD LT MC OA PG PH PRW	ACCESS DOOR ABOVE FINISHED FLOOR AUTOMATIC SPRINKLER RISER BOILER BACKDRAFT DAMPER COMBUSTION AIR CAST IRON CLEAN OUT CONDENSING UNIT CIRCULATING PUMPS CONNECTION CONSTANT VOLUME BOX EXHAUST AIR GRILLE ELECTRICAL CONTRACTOR EXHAUST FAN ELECTRIC WATER COOLER ELECTRIC WALL HEATER EXHAUST FURNACE FLOOR DRAIN FLOOR FREEZE PROOF FLOOR SINK FUNNEL TYPE FLOOR DRAIN GENERAL CONTRACTOR LAVATORY LINEAR DIFFUSER LAUNDRY TUB MECHANICAL CONTRACTOR OUTSIDE AIR PRESSURE GAUGE PHYSICALLY HANDICAPPED PRESSURE REGULATING VALVE	RZP- BFP SK SA SAG SHR TAG SHR TAG VD VTR VD VTR WCO WH VV BPW TCP DWV WB F.U GLV H.B H.C H.O I.E M.H.C	REDUCED ZONE BACKFLOW PREVENTER SINK SUPPLY AIR SUPPLY AIR DIFFUSER SUPPLY AIR GRILLE SHOWER MOP SINK TRANSFER AIR GRILLE THERMOMETER UNIT HEATER UNIT HEATER URINAL VOLUME DAMPER VENT THROUGH ROOF WATER CLOSET WALL CLEAN OUT WATER HEATER WASTE/VENT BED PAN WASHER TEMPERATURE CONTROL PANEL DRAINAGE WASTE AND VENT WATER BOX FIXTURE UNITS DRAINAGE GATE VALVE GLOBE VALVE HOSE BIBB HOSE CABINET HYDRANT HUB OUTLET INVERT ELEVATION MANHOLE NOT IN CONTRACT		COLD WATER HOT WATER HOT WATER RETURN NATURAL GAS LIQUID (REFRIGERANT) SUCTION (REFRIGERANT) SUCTION (REFRIGERANT) SANITARY STORM VENT FIRE PROTECTION EXISTING DEMOLISHED NEW RETURN GRILLE SUPPLY DIFFUSER FIRE DAMPER HORIZON FIRE DAMPER VERTICAI VOLUME DAMPER SMOKE/FIRE DAMPER BALL VALVE CHECK VALVE CONTROL VALVE EXPANSION JOINT UNION GATE VALVE SOLENOID VALVE EXPANSION JOINT FLOW ARROW FLOW SWITCH
RA	RETURN AIR	R.C	ROOF CONDUCTOR	Mww	MOTORIZED DAMPER
RAG	RETURN AIR GRILLE	R.D	ROOF DRAIN	(S) (D) (D) (D)	SENSOR
RH	RADIANT HEATER	TYP.	TYPICAL	Ū	THERMOSTAT
RS	ROOF SUMP	W	WASTE	(SD)	SMOKE DETECTOR

ERV

ENERGY RECOVERY VENTILATOR

PHYSICALLY HANDICAPPED

MECHANICAL LEGEND

ES/FIXTURES SHALL ETC. EEDED FOR
D AND SUCTION

COLD WATER HOT WATER HOT WATER RETURN NATURAL GAS LIQUID (REFRIGERANT SUCTION (REFRIGERANT)

FIRE PROTECTION DEMOLISHED **RETURN GRILLE** SUPPLY DIFFUSER FIRE DAMPER HORIZONTAL FIRE DAMPER VERTICAL VOLUME DAMPER


THERMOSTAT SMOKE DETECTOR THERMOMETER

FIXTURE SCHEDULE

- WC-1 KOHLER MODEL #K-3519-T-O (16 1/2" HDCP.) WELLWORTH. W/ FLUSH LEVER TO OPEN SIDE OF ROOM, ELONGATED TANK TYPE. SEAT - "BEMIS" NO. 1955SSTFR, WHITE MCGUIRE NO. 2166CC CLOSET SUPPLY (1/2"C.W., 4"W., 2"V.)
- MB-1 ZURN SERVICE SINK MODEL NO. Z1996-24-SD-BS-WG-HH-MH WITH MODEL NO. Z843M1-RC-XL WALL MOUNTED FAUCET WITH BRACKET AND PAIL HOOK (3/4"C.W., 3/4"H.W., 2"W., 1-1/2"V.)
- WH-1 NAVIEN MOD NPE-240A-NG COMMERCIAL GAS TANKLESS WATER HEATER RECOVERY RATING 5.6 GPM @ 70°, 200 MBTU NAT GAS, 96% EFFICIENT, 1/2" CONDENSATE DRAIN, 3/4" HW, CW, & HWR, 2" PVC FLUE AND COMBUSTION AIR VENTED THRU ROOF, INSTALLED AS PER MANUFACTURES RECOMMENDATIONS.


WHA MECHANICAL WATER HAMMER ARRESTOR. LOCATE & INSTALL PER MANUFACTURER'S RECOMMENDATIONS.

- MV WATTS MMV-M1, ASSE 1070 MIXING VALVE, 2 GPM @ 10 PSIG PD.
- AAV AIR ADMITTANCE VALVE STUDOR MINI VENT
- EWC DRINKING FOUNTAIN LVRCTL8WSK ELKAY EZH20 BOTTLE FILLING STATION AND HIGH/LOW EFFICIENCY VANDAL RESISTANT COOLER FILTERED REFRIGERATED STAINLESS
- ELKAY MODEL ELX1616 ELKAY QUARTZ LUXE SINGLE BOWLSINK BLACK (CA) WITH DELTA DSP-L-35849LF NICOLI SK-1 COLLECTION TWO HANDLE WIDESPREAD DECK MOUNT FAUCET, McGUIRE W/20" RISERS MO.2165CC, DEARBORN BRASS TRAP NO. 704-2 (PVC), PROFLO PFGD101 GRID DRAIN (1/2" CW, 1/2" HW, 1 1/2" W, 1 1/2" V) ASSE 1070 TEMPERING VALVE. CABINET INSTALLER TO CUT OPENINGS.
- ELKAY MODEL 'LUSTERTONE' LR2519 18 GA TYPE 304 STAINLESS STEEL SINK WITH LK530 BH4 KITCHEN FAUCET WITH 4" SK-2 BLADE HANDLES AND GOOSENECK, McGUIRE W/20" RISERS MO.2165CC, DEARBORN BRASS TRAP NO. 704-2 (PVC), PROFLO PFGD101 GRID DRAIN (1/2" CW, 1/2" HW, 1 1/2" W, 1 1/2" V) ASSE 1070 TEMPERING VALVE. CABINET INSTALLER TO CUT OPENINGS. L-1
 - KOHLER "BRYANT OVAL" DROP IN 20"x16" CHINA, BLACK, NO. K-2699-1, BRADLEY VERGE LINEA SERIES FAUCET NO. S53-3500 BRUSHED BLACK STAINLESS AND MATCHING COLOR GRID DRAIN, DEARBORN BRASS TRAP NO.701-1 (PVC),McGUIRE W/20" RISERS MO.2165CC W/ POINT OF USE TEMPERING VALVE (ASSE 1070). (1/2"C.W., 1/2"H.W., 1-1/2"W., 1-1/2"V.)
- 6" ROUND PVC FLOOR DRAIN ZURN FR06NI-CS-P 3 S-CC WITH ZN400BZ-VP STRAINER, AND WITH 'SURE SEAL' IN LINE FD-1 TRAP SEALER MOD. SS300NV (2"W).
- ET-1 EXPANSION TANK, AMTROL ST-1, ASME RATED, 5 GALLON
- WH WOODFORD 65-C FREEZELESS WALL HYDRANT

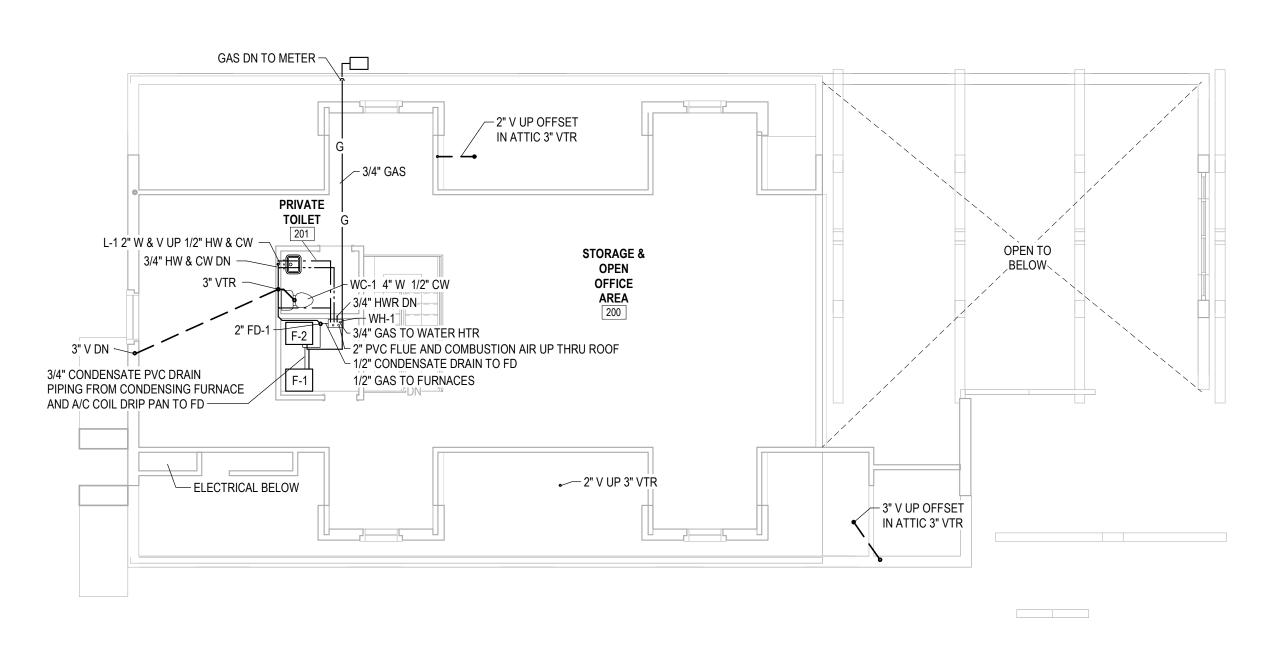




2 Second Floor Plumbing Plan

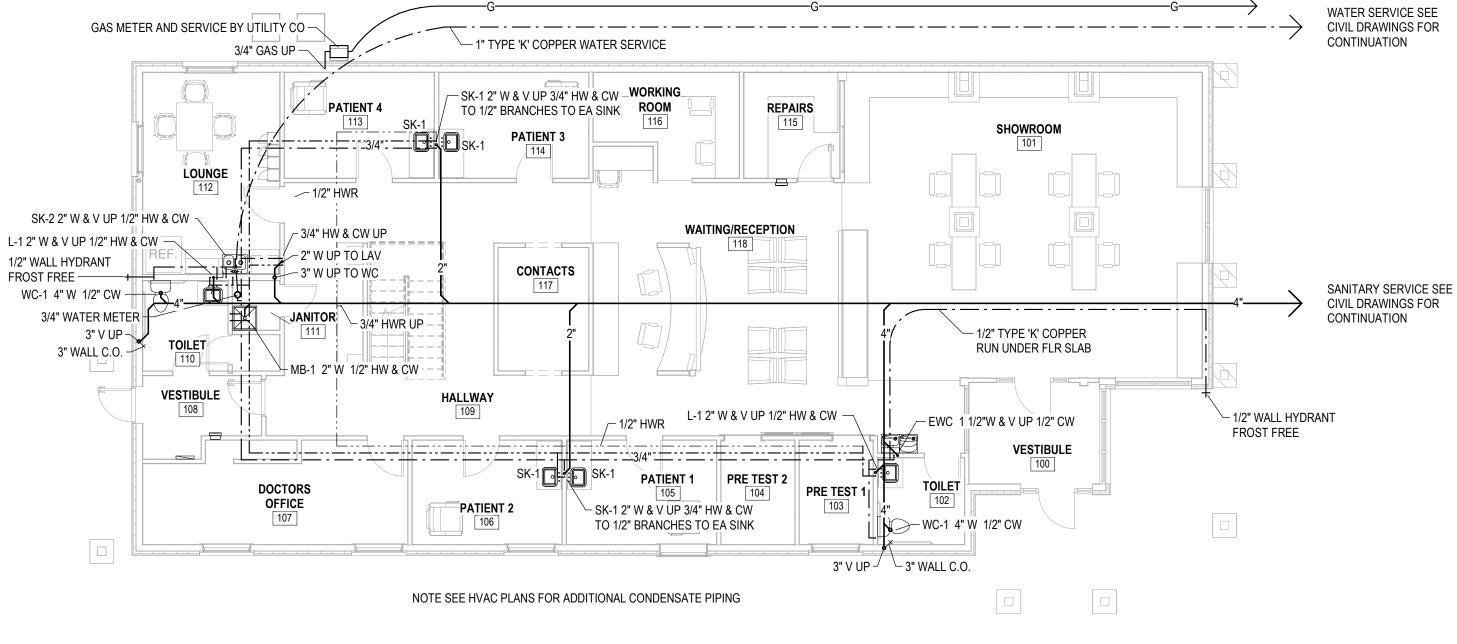



GAS SERVICE TO LEROY ST MAIN

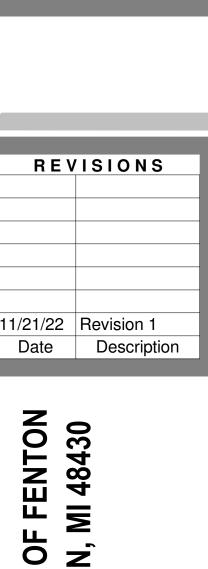

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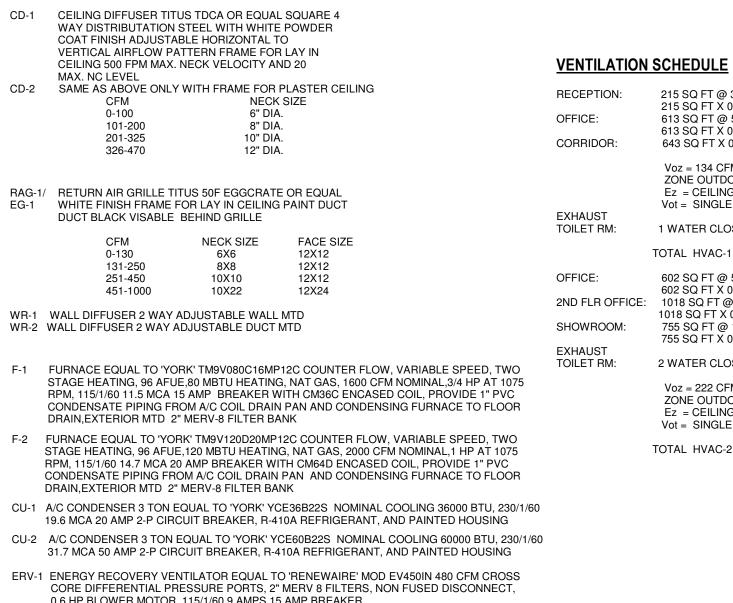
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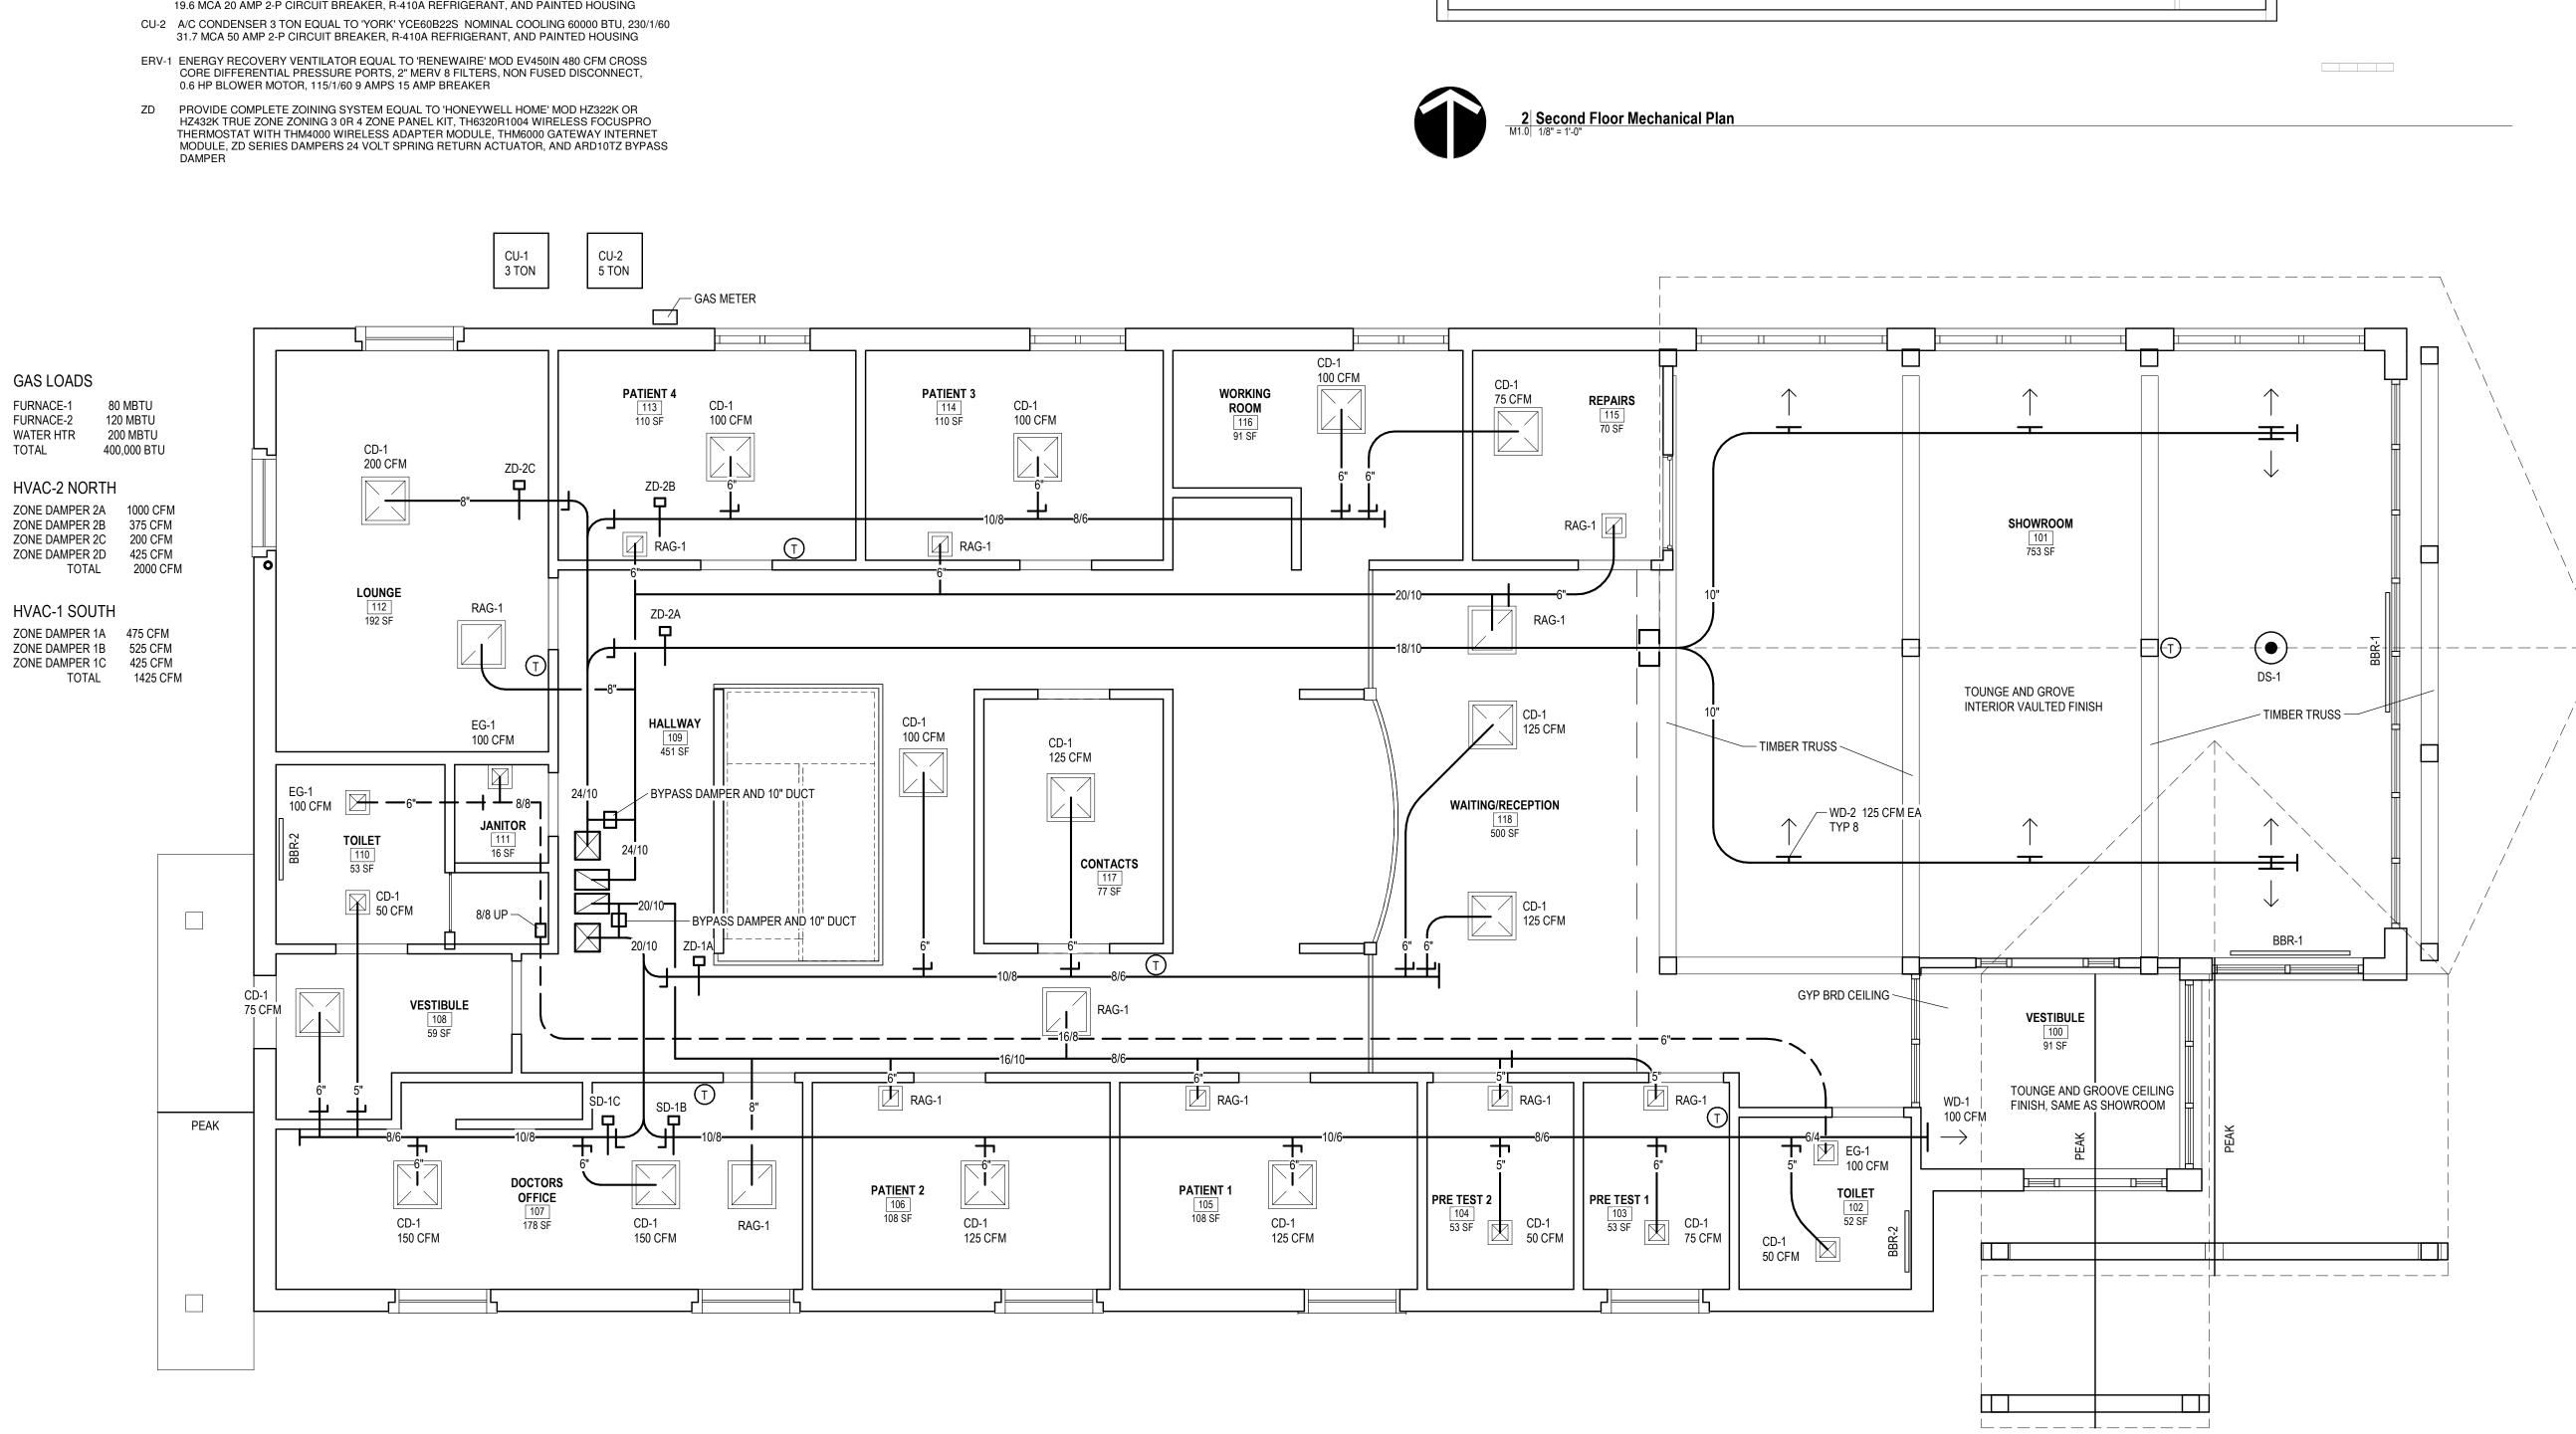
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EQUIPMENT SCHEDULE

TOTAL



HZ432K TRUE ZONE ZONING 3 0R 4 ZONE PANEL KIT, TH6320R1004 WIRELESS FOCUSPRO THERMOSTAT WITH THM4000 WIRELESS ADAPTER MODULE, THM6000 GATEWAY INTERNET



215 SQ FT @ 30 PERSONS/1000 SQ FT = 6 PERSONS X 5 CFM = 30 CFM 215 SQ FT X 0.06 CFM/SQ FT = 13 CFM 613 SQ FT @ 5 PERSONS/1000 SQ FT = 3 PERSONS X 5 CFM = 15 CFM 613 SQ FT X 0.06 CFM/SQ FT = 37 CFM

643 SQ FT X 0.06 CFM/SQ FT = 39 CFM Voz = 134 CFM


ZONE OUTDOOR AIRFLOW Voz = Vbz / Ez Voz = 134/1 OR 134 CFM Ez = CEILING SUPPLY AND RETURN MMC TABLE 403.3.1.2 NOTE g Vot = SINGLE ZONE SYSTEM (1) X Voz (134 CFM) OR 134 CFM

1 WATER CLOSET X 50 CFM = 50 CFM TOTAL HVAC-1 FRESH AIR 134 CFM


602 SQ FT @ 5 PERSONS/1000 SQ FT = 3 PERSONS X 5 CFM = 15 CFM 602 SQ FT X 0.06 CFM/SQ FT = 36 CFM 2ND FLR OFFICE: 1018 SQ FT @ 5 PERSONS/1000 SQ FT = 5 PERSONS X 5 CFM = 25 CFM 1018 SQ FT X 0.06 CFM/SQ FT = 61 CFM 755 SQ FT @ 10 PERSONS/1000 SQ FT = 8 PERSONS X 5 CFM = 40 CFM 755 SQ FT X 0.06 CFM/SQ FT = 45 CFM


2 WATER CLOSET X 50 CFM = 100 CFM

- Voz = 222 CFM ZONE OUTDOOR AIRFLOW Voz = Vbz / Ez Voz = 222/1 OR 222 CFM Ez = CEILING SUPPLY AND RETURN MMC TABLE 403.3.1.2 NOTE g Vot = SINGLE ZONE SYSTEM (1) X Voz (222 CFM) OR 222 CFM
- TOTAL HVAC-2 FRESH AIR 222 CFM

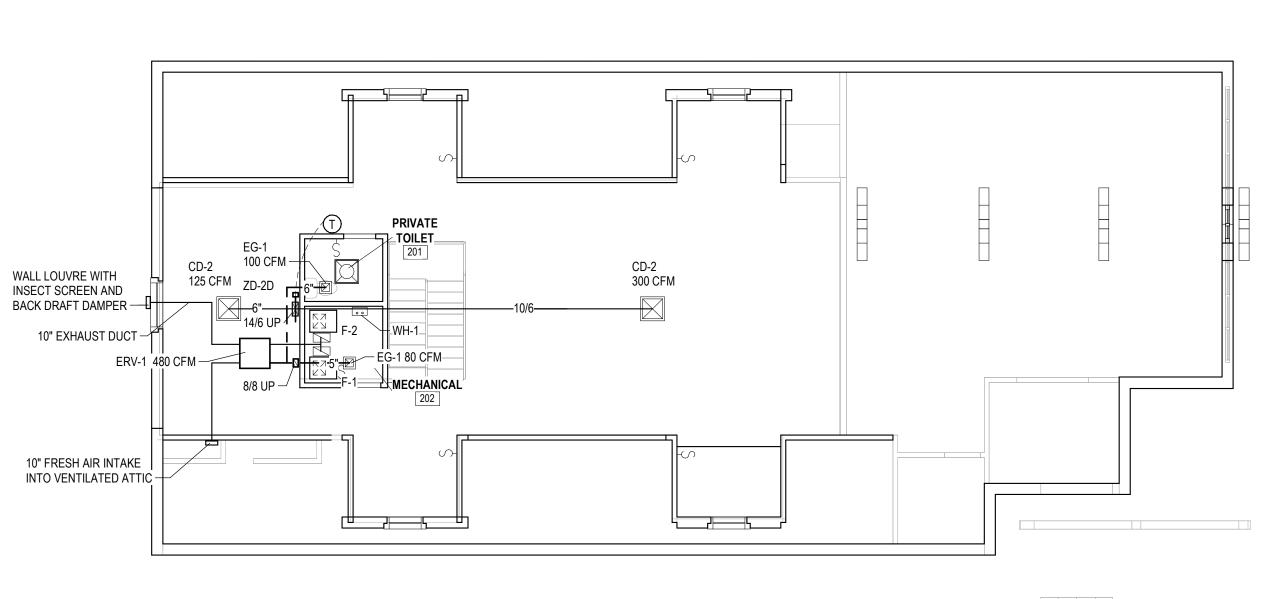



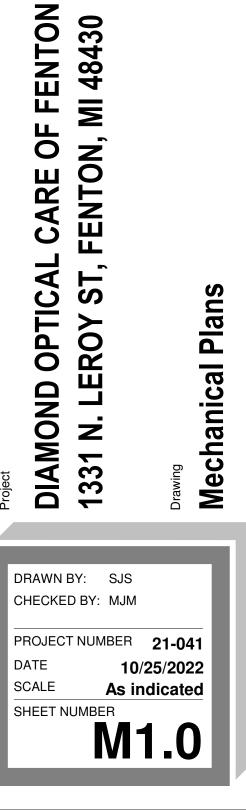

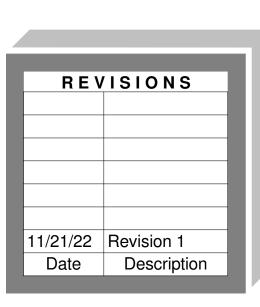



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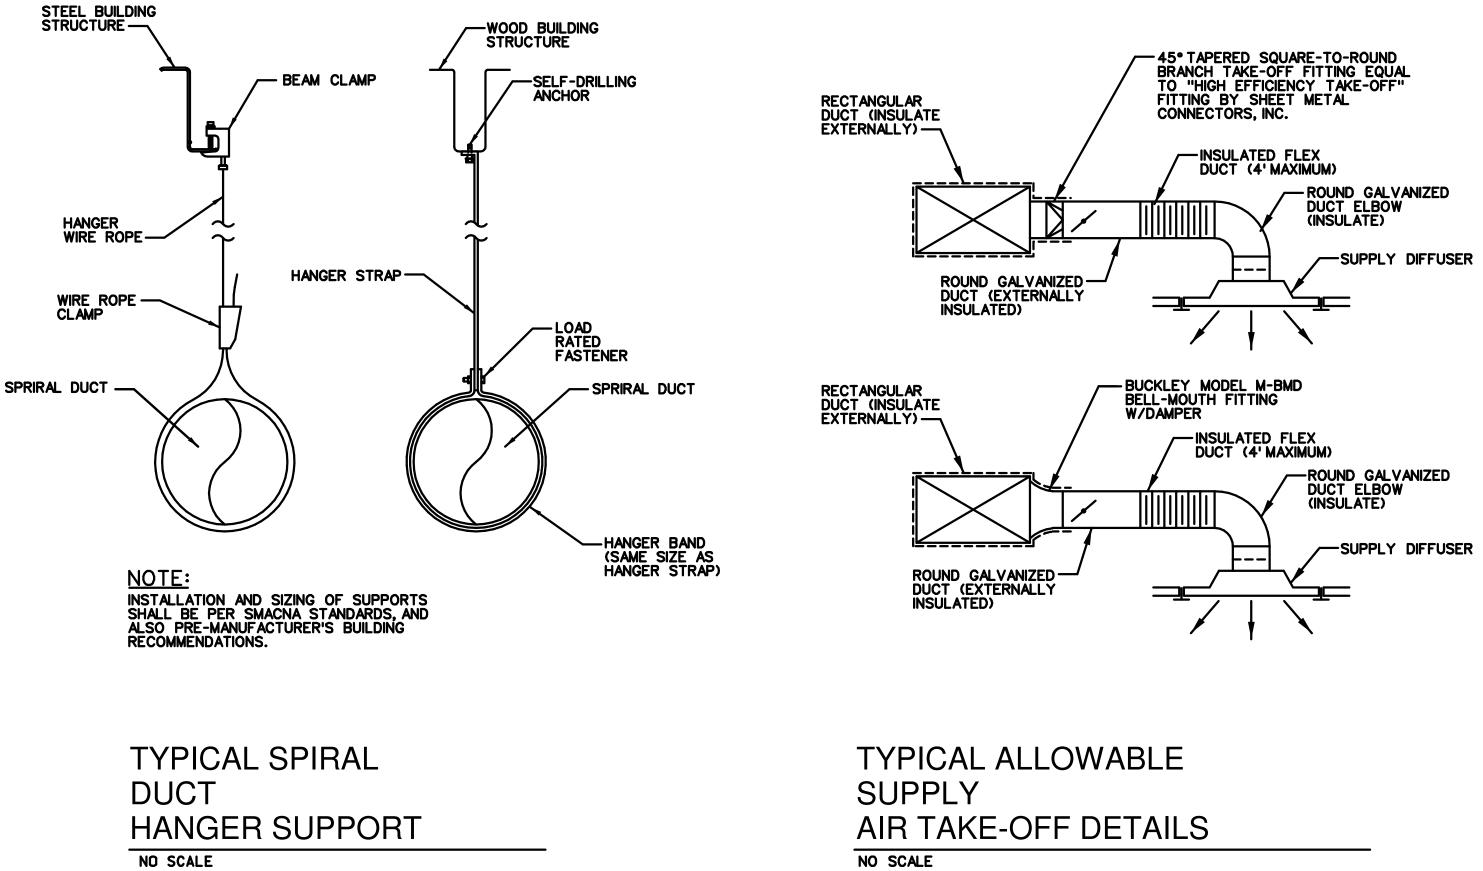
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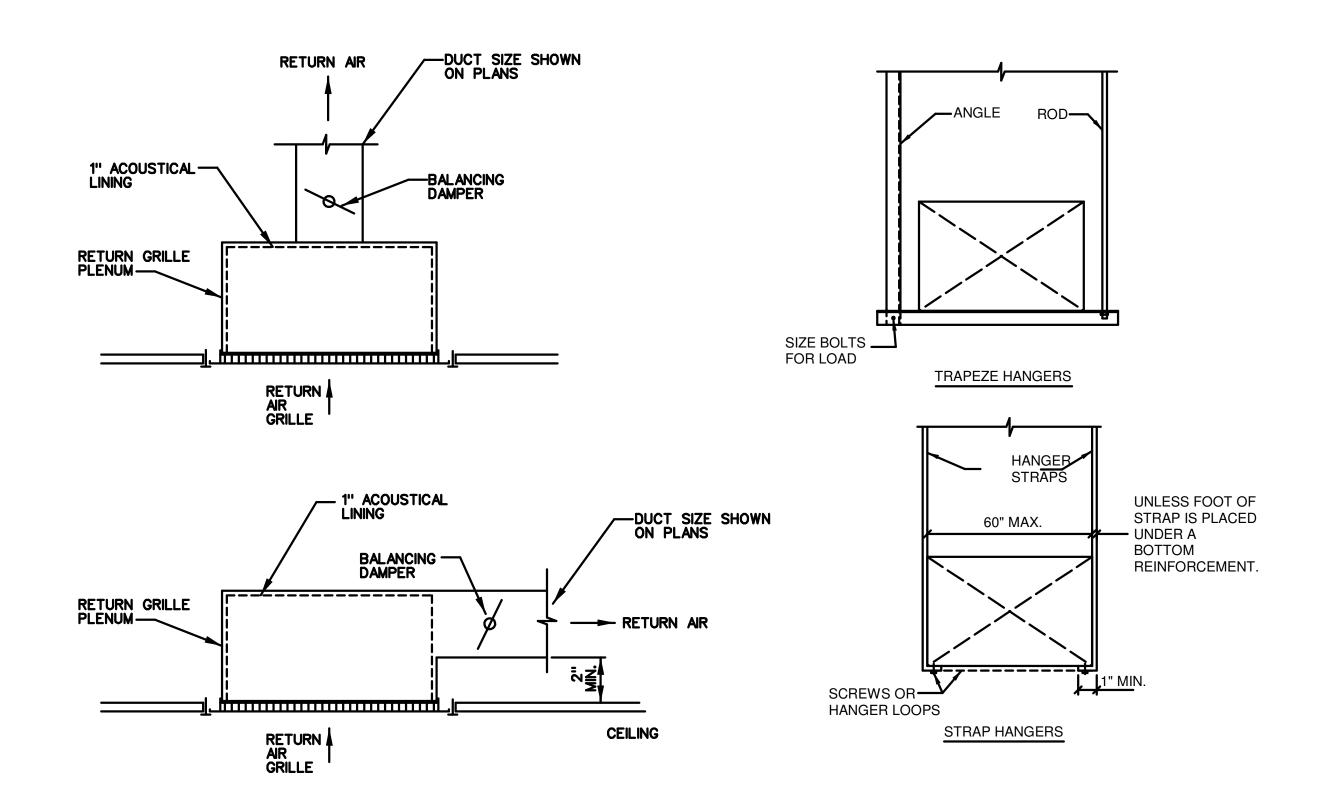
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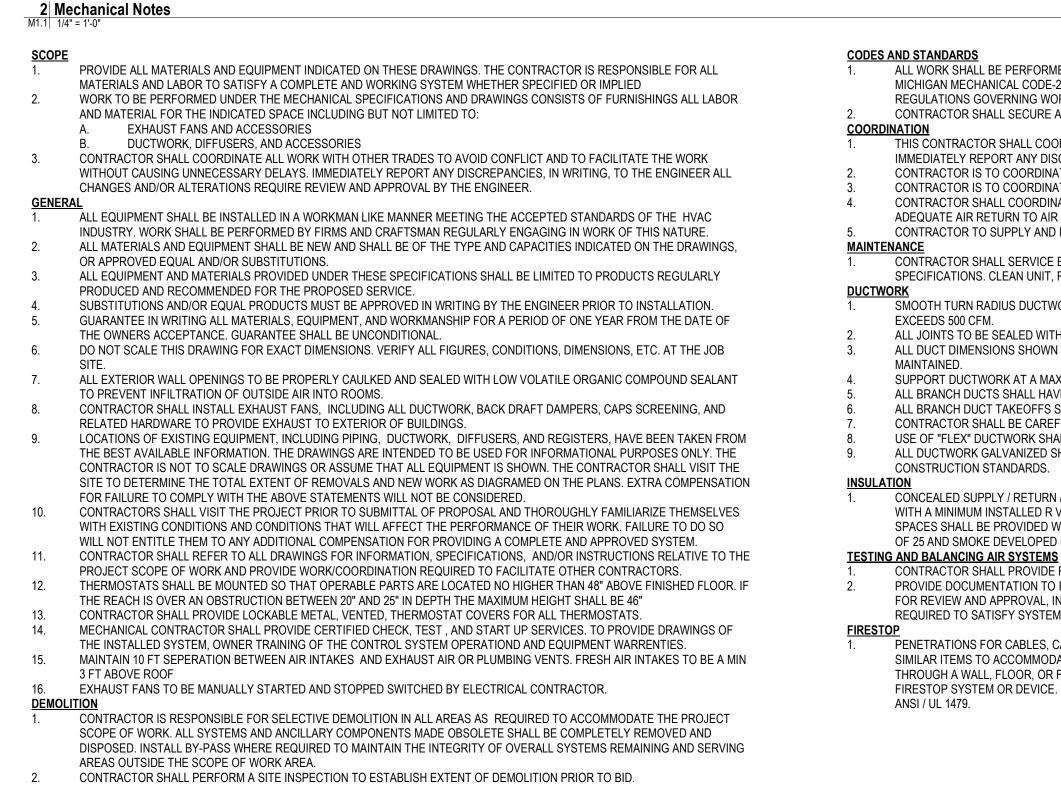
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RETURN AIR GRILLE DETAIL





TYPICAL DUCT HANGERS

NOT TO SCALE

- NOTES: REINFORCEMENT MAY BE USED FOR ATTACHMENT IF IT QUALIFIES FOR BOTH DUTIES.
- DO NOT EXCEED ALLOWABLE LOAD LIMITS

ALL WORK SHALL BE PERFORMED IN STRICT COMPLIANCE WITH THE LATEST EDITION OF INTERNATIONAL MECHANICAL CODE. MICHIGAN MECHANICAL CODE-2015, MICHIGAN ENERGY CODE ASHRA 90.1 2015, NFPA, SMACNA, LOCAL CODES, AND REGULATIONS GOVERNING WORK OF THIS NATURE.

- CONTRACTOR SHALL SECURE ALL PERMITS OR APPLICATIONS, AND PAY ANY AND ALL FEES AS REQUIRED.
- THIS CONTRACTOR SHALL COORDINATE ALL WORK WITH A COMPLETE SET OF M/P/E AND ARCHITECTURAL DESIGN DRAWINGS.
- IMMEDIATELY REPORT ANY DISCREPANCIES TO THE ENGINEERS OFFICE. CONTRACTOR IS TO COORDINATE AND PROVIDE FOR INTERIOR WALL OPENINGS FOR DUCT PENETRATIONS.
- CONTRACTOR IS TO COORDINATE WITH ELECTRICAL CONTRACTOR FOR LOCATIONS OF WIRING FOR EACH EXHAUST FAN. CONTRACTOR SHALL COORDINATE AND PROVIDE FOR UNDERCUTTING AND/OR LOUVRE DOOR AS INDICATED TO ALLOW ADEQUATE AIR RETURN TO AIR HANDLING UNIT.
- CONTRACTOR TO SUPPLY AND INSTALL ALL CONTROL WIRING AND THERMOSTATS AS REQUIRED.

CONTRACTOR SHALL SERVICE EXISTING HVAC EQUIPMENT TO ASSURE OPERATIONS IS IN COMPLIANCE WITH MANUFACTURERS SPECIFICATIONS. CLEAN UNIT, REPLACE FILTERS, AND RECHARGE REFRIGERANT AS NEEDED.

SMOOTH TURN RADIUS DUCTWORK OF DOUBLE THICKNESS TURNING VANES SHALL BE USED THROUGHOUT WHERE FLOW

ALL JOINTS TO BE SEALED WITH DUCT MASTIC AND TAPE IN ACCORDANCE WITH SMACNA STANDARDS CLASS 'C'. ALL DUCT DIMENSIONS SHOWN ARE NET INSIDE VALUES. DIMENSIONS MAY BE CHANGED AS LONG AS NET FREE FACE AREA IS

SUPPORT DUCTWORK AT A MAXIMUM INTERVAL OF 16'-0" AND NO MORE THAN 2'-0" FROM FITTINGS AND BRANCH TAKEOFFS. ALL BRANCH DUCTS SHALL HAVE A VOLUME DAMPER.

ALL BRANCH DUCT TAKEOFFS SHALL BE MADE WITH 45° ENTRY TYPE FITTINGS. CONTRACTOR SHALL BE CAREFUL SO AS NOT TO KINK OR COLLAPSE FLEXIBLE DUCT.

USE OF "FLEX" DUCTWORK SHALL BE LIMITED TO NO MORE THAN 6' LINEAR FEET PER RUN UNLESS OTHERWISE INDICATED. ALL DUCTWORK GALVANIZED SHEETMETAL SUPPLY AND RETURN AIR DUCT 2" WG EXHAUST DUCT 1" WG SMACNA CONSTRUCTION STANDARDS.


CONCEALED SUPPLY / RETURN / OUTSIDE AIR DUCTWORK SHALL BE WRAPPED WITH 1 1/2" THICK FIBERGLASS DUCT INSULATION WITH A MINIMUM INSTALLED R VALUE OF 4.2. SYSTEM SHALL INCLUDE FRK EXTERIOR. EXPOSED DUCTWORK TO OCCUPIED SPACES SHALL BE PROVIDED WITH 1" BARRIER TO PREVENT CONDENSATION. INSULATION SHALL HAVE A FLAME SPREAD RATING OF 25 AND SMOKE DEVELOPED RATING OF 50.

CONTRACTOR SHALL PROVIDE FOR BALANCING OF AIR SYSTEMS TO ACHIEVE VALUES SHOWN ON THE DRAWINGS. PROVIDE DOCUMENTATION TO ENGINEERS OFFICE BY AN INDEPENDANT NEBB OR AABC CERTIFIED TESTAND BALANCE AGENCY FOR REVIEW AND APPROVAL, INDICATING RESULTING AIR FLOWS FROM PERFORMANCE OF BALANCING. RE-BALANCE SYSTEM AS REQUIRED TO SATISFY SYSTEM REQUIREMENTS.

PENETRATIONS FOR CABLES, CABLETRAYS, CONDUITS, PIPES, TUBES, COMBUSTION VENTS, AND EXHAUST VENTS, WIRES, AND SIMILAR ITEMS TO ACCOMMODATE ELECTRICAL, MECHANICAL, PLUMBING, AND COMMUNICATIONS SYSTEMS THAT PASS THROUGH A WALL, FLOOR, OR FLOOR/CEILING ASSEMBLY CONSTRUCTED AS A FIRE BARRIER SHALL BE PROTECTED BY A FIRESTOP SYSTEM OR DEVICE. THE FIRESTOP SYSTEM OR DEVICE SHALL BE TESTING IN ACCORDANCE WITH ASTM E 814 OR

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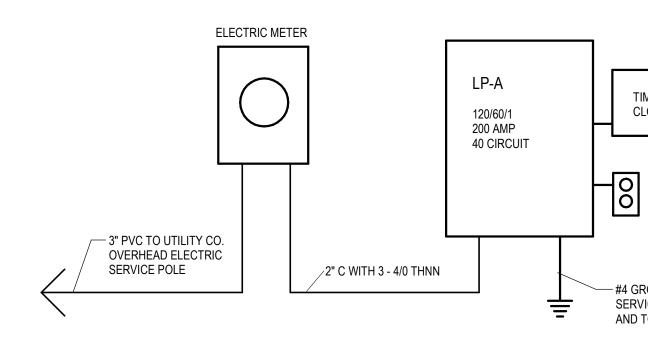
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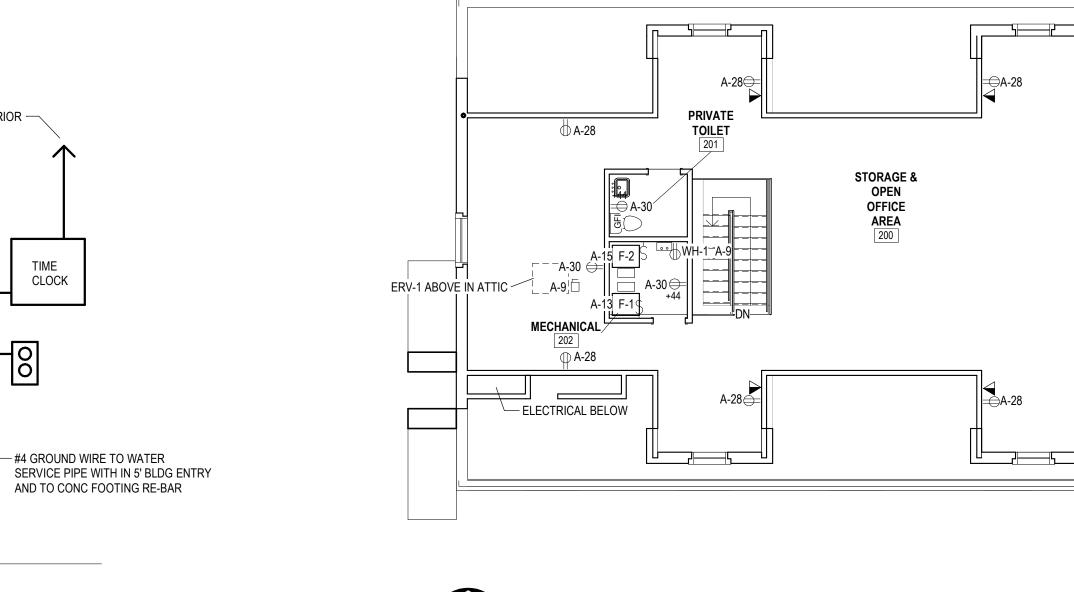


5 Electric Riser Diagram

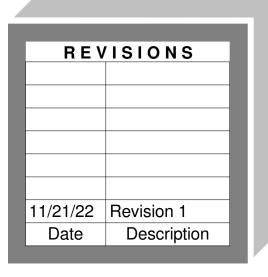
12	0/240V 60) HZ 1 PHASE 3 WIRE 20	0 AMP M.B.	225 A	MP BUS	S 10K A.I.C.		
NO	BKR	DESCRIPTION	LOAD		LOAD	DESCRIPTION	BKR	N
1	20A	CU-1 3 TON	2.25	А	1.08	RECEPTACLE RM 101	20A	2
3	2P		2.25	В	0.72	RECEPTACLE RM 101	20A	4
5	50A	CU-2 5 TON	3.65	А	0.90	RECEPTACLE RM 100	20A	6
7	2P		3.65	В	0.72	RECEPTACLE RM 118	20A	8
9	20A	WATER HTR ERV-1	1.12	А	1.26	RECEPTACLE RM 117	20A	10
11	20A	SPARE		В	0.90	RECEPTACLE RM 115	20A	12
13	15A	FURNACE-1	1.32	А	0.90	RECEPTACLE RM 116	20A	14
15	20A	FURNACE-2	1.69	В	1.08	RECEPTACLE RM 113, 114	20A	16
17	20A	ELECTRIC WATER COOLER	0.40	А	1.08	RECEPTACLE RM 105,106	20A	18
19	20A	RECEPTACLE RM 110, 111	0.36	В	0.90	RECEPTACLE RM 107	20A	20
21	20A	ELECT BASEBRD HTR	1.25	А	0.90	RECEPTACLE RM 109	20A	22
23	20A	ELECT BASEBRD HTR	1.25	В	0.36	RECEPTACLE RM 112	20A	24
25	20A	ELECT BASEBRD HTR	0.50	А	0.90	RECEPTACLE RM 112	20A	26
27	20A	ELECT BASEBRD HTR	0.50	В	1.08	RECEPTACLE RM 200	20A	28
29	20A	TELEPHONE SYSTEM	0.50	А	0.36	RECEPTACLE RM 201,202	20A	30
31	20A	SECURITY SYSTEM	0.50	В	0.28	LIGHTING PARKING	20A	32
33	20A	SPARE		А	1.67	LIGHTING NORTH	20A	34
35	20A	SPARE		В	1.45	LIGHTING SOUTH & 2ND FLR	20A	36
37		BLANK		А		SPARE	20A	38
39		BLANK		В		SPARE	20A	40
41		BLANK				BLANK		42


LIGHTING	3.4 KVA	AT 12	5% =	=	4250 VA	
RECEPTACLE	10.0 KVA	AT 10	0% =	=	10000 VA	
RECEPTACLE	3.5 KVA	AT 5	0%	=	1750 VA	
MISC	9.03 KVA	AT 80	0%	=	7224 VA	
A/C CONDENSERS	11.8 KVA	AT 10	0%	=	11800 VA	
25% LARGEST MOTOR LOA	D 0.25 X 7.	3 KVA		=	1825 VA	
TOTAL; CONNECTED	37.73 KVA		DEMAND	=	36849 VA	153.54 AMPS


ELECTRICAL LEGEND				
►	DATA OUTLET			
	TELEPHONE OUTLET & DATA			
\triangleright	TELEPHONE OUTLET			
J	JUNCTION BOX			
	JUNCTION BOX EXISTING			
Ś	MOTOR SINGLE PHASE			
<u>ر</u>	MOTOR THREE PHASE			
pao J	POWER ASSIST OPENER			
eds J	JUNCTION BOX (ELECTRIC DOOR STRIKE)			
	DISCONNECT			
NF	DISCONNECT NON-FUSED			
ESH	OCCUPANCY SENSOR WALL MOUNTED			
ES	OCCUPANCY SENSOR CEILING MOUNTED			
EPT	EMERGENCY POWER TRANSFER SWITCH LVS MOD. EPC-A			



2 Second Floor Electrical Plan E1.0 1/8" = 1'-0"

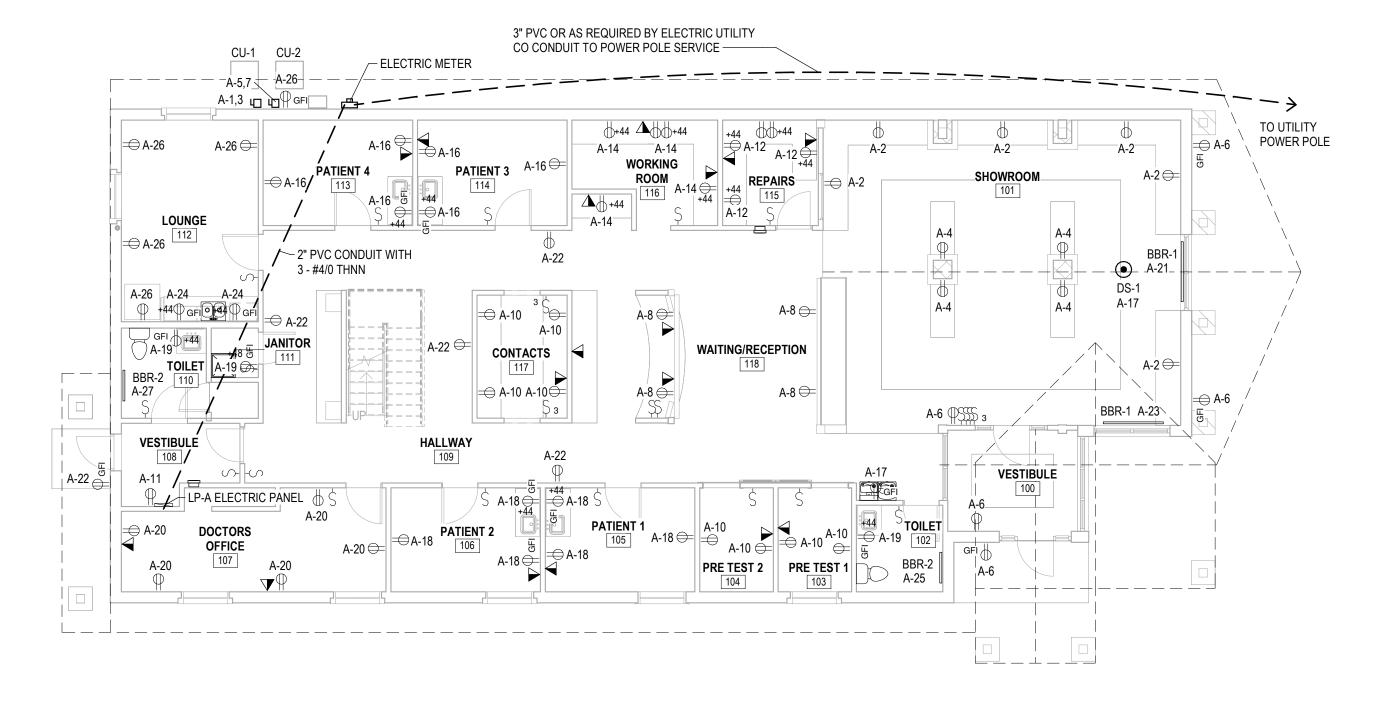

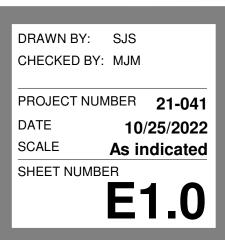

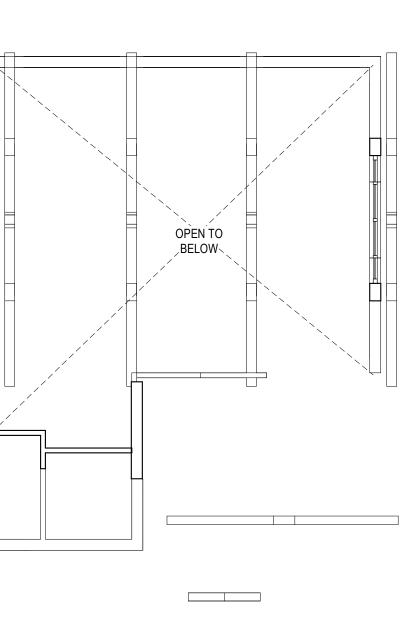


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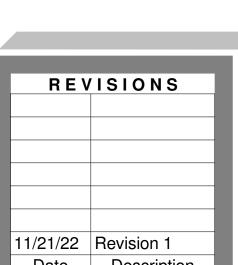
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EXISTING OUTLET DUPLEX RECEPTACLE QUADRAPLEX RECEPTACLE DUPLEX RECEPTACLE GROUND FAULT INTERRUPTER DUPLEX RECEPTACLE DEDICATED CIRCUIT WEATHERPROOF SINGLE POLE SWITCH SINGLE POLE SWITCH EXISTING THREE WAY SWITCH DIMMER SWITCH TELEVISION OUTLET (EACH OUTLET TO BE HOME RUN TO TV CONTROL PANEL)

SMOKE DETECTOR





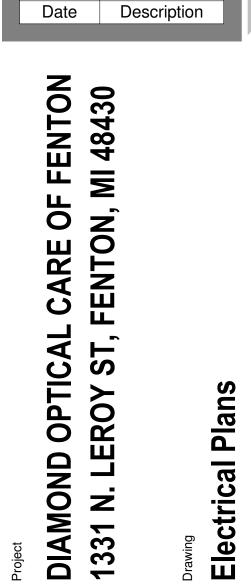

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SEAL OF ARCHITECT

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ELECTRICAL SPECIFICATIONS

ALL ELECTRICAL WORK SHALL COMPLY WITH THE LATEST EDITION OF N.E.C., LOCAL AND STATE CODES, ORDINANCES AND REGULATIONS, INCLUDING THE OCCUPATIONAL SAFETY AND HEALTH ACT (OSHA).

WORK INCLUDED

THE CONTRACTOR SHALL PROVIDE ALL ITEMS, ARTICLES, MATERIALS, OPERATIONS, OR METHODS MENTIONED, LISTED OR SCHEDULED ON THE DRAWINGS AND IN THESE SPECIFICATIONS, INCLUDING ALL LABOR, MATERIALS, EQUIPMENT, AND ALL INCIDENTALS NECESSARY REQUIRED FOR THE COMPLETION AND OPERATION OF ALL SYSTEMS.

LOCAL CONDITIONS

THE CONTRACTOR SHALL VISIT THE SITE AND SHALL FAMILIARIZE HIMSELF WITH CONDITIONS WHICH WILL AFFECT THE WORK HE IS TO PERFORM.

PERMITS & INSPECTIONS

THE CONTRACTOR SHALL TAKE OUT ALL PERMITS AND ARRANGE FOR ALL NECESSARY INSPECTIONS AND SHALL PAY ALL FEES AND EXPENSES IN CONNECTION THEREWITH AS A PART OF HIS WORK UNDER THEIR CONTRACT.

SCHEDULE OF WORK

COORDINATE ALL WORK WITH THAT OF OTHER TRADES. PERFORM WORK IN A PHASED MANNER AS REQUIRED TO ACCOMMODATE THE PROJECT CONSTRUCTION SCHEDULE. COORDINATE ALL WORK AND THE SEQUENCE OF INSTALLATION WITH THE GC/CONSTRUCTION MANAGER.

GUARANTEE & WARRANTY

CONTRACTOR SHALL GUARANTEE ALL WORK INSTALLED BY HIM OR HIS SUBCONTRACTORS TO BE FREE FROM DEFECT IN MATERIAL AND WORKMANSHIP FOR A PERIOD OF ONE YEAR FOLLOWING THE DATE OF FINAL ACCEPTANCE OF THE WORK, UNLESS A LONGER PERIOD IS STIPULATED UNDER SPECIFIC HEADINGS, AND HE SHALL REPAIR OR REPLACE AT NO ADDITIONAL COST TO THE OWNER, ANY MATERIAL OR EQUIPMENT DEVELOPING DEFECTS AND SHALL ALSO MAKE GOOD ANY DAMAGE CAUSED BY SUCH DEFECTS OR THE CORRECTION OF DEFECTS.

CUTTING & PATCHING

NO CUTTING OR BURNING OF HOLES THROUGH BEAMS OR OTHER STRUCTURAL MEMBERS SHALL BE DONE WITHOUT THE SPECIFIC PERMISSION OF THE ARCHITECT.

ALL OPENINGS IN WALLS, CEILINGS, OR FLOORS MADE BY THE CONTRACTOR SHALL BE NEATLY PATCHED BY THE SAME AFTER OTHER WORK IS DONE.

ALL CABINETS, CONDUIT SYSTEMS, PANELBOARDS, ETC., SHALL BE THOROUGHLY GROUNDED IN ACCORDANCE WITH THE REQUIREMENTS OF THE NATIONAL ELECTRICAL CODE.

CONDUITS & FITTINGS CONDUIT 2" AND SMALLER WHICH IS CONCEALED IN DRYWALL PARTITIONS, ABOVE ACCESSIBLE CEILINGS AND WHERE EXPOSED ABOVE 48" AFF, SHALL BE ELECTRICAL METALLIC TUBING.

CONDUITS EXPOSED TO THE WEATHER SHALL BE RIGID GALVANIZED CONDUITS. CONDUIT FITTINGS AT THESE LOCATIONS SHALL BE NONFERROUS CAST TYPE EQUIPPED WITH GASKETED COVERS.

ALL CONDUIT SHALL BE SECURELY FASTENED IN PLACE WITH APPROVED CLAMPS AND CAREFULLY REAMED BEFORE INSTALLING.

CONDUITS IN MECHANICAL EQUIPMENT SPACES AND UNFINISHED AREAS MAY BE RUN EXPOSED. ALL OTHER CONDUIT SHALL BE CONCEALED, UNLESS OTHERWISE NOTED. EXPOSED CONDUIT SHALL BE INSTALLED PARALLEL, OR AT RIGHT ANGLES TO ADJACENT BUILDING LINES AND SHALL BE SUPPORTED AT INTERVALS NOT EXCEEDING EIGHT FEET.

GROUPS OF CONDUITS, WHERE SUSPENDED, SHALL BE SUPPORTED ON TRAPEZE TYPE HANGERS, USING 3/8" ROD AND CHANNEL IRON OR UNISTRUT. INDIVIDUAL CONDUITS NOT SUPPORTED ON PIPE STRAPS SHALL BE PROVIDED WITH CONDUIT CLAMPS OR RING HANGERS SUSPENDED ON RODS. PERFORATED IRON STRAPS OR SOFT IRON WIRE FOR PIPE SUPPORTS SHALL NOT BE USED.

CONNECTORS AND COUPLINGS FOR ELECTRICAL METALLIC TUBING SHALL BE OF THE SET- SCREW TYPE AS MANUFACTURED BY T & B, MIDWEST, OR ELECTRIC TUBE PRODUCTS CO.

ALL CONDUITS CALLED OUT TO BE STUBBED OFF, SHALL HAVE PROPER BUSHINGS, FINISH, ETC. SO THAT NO ROUGH EDGES ARE LEFT AT END OF CONDUITS.

ALL WIRING SHALL BE ENCLOSED IN A METAL RACEWAY, UNLESS OTHERWISE NOTED.

ALL EMPTY CONDUITS SHALL HAVE A NYLON "FISH TAPE" LEFT IN THEM.

ALL WALL AND FLOOR PENETRATIONS SHALL BE FIRE RATED TO MAINTAIN RATING OF SURFACE PENETRATED OR 1 HOUR RATING MINIMUM. SEALING SHALL BE WITH 3M #CP25 FIRE PUTTY OR EQUAL BY NELSON.

OUTLET BOXES

ALL FLUSH MOUNTED OUTLET BOXES SHALL BE STANDARD GALVANIZED STEEL TYPE NOT LESS THAN 1-1/2" DEEP, OF TYPE AND SIZE TO ACCOMMODATE DEVICES SPECIFIED WITH PROPER SPACE FOR WIRE AND SUPPORTS. BOXES SHALL BE EQUIPPED WITH PLASTER RINGS OR COVERS AS REQUIRED.

ALL OUTLET BOXES, PULL BOXES AND JUNCTION BOXES SHALL BE RIGIDLY SECURED IN PLACE IN AN APPROVED METHOD.

CONDUCTORS OF FIRE ALARM AND FIRE PROTECTION CIRCUITS SHALL NOT BE INSTALLED IN THE SAME CONDUIT WITH CIRCUITS OF OTHER SYSTEMS. NO OUTLET BOX FOR ONE CONDUIT SYSTEM SHALL BE USED AS A JUNCTION BOX FOR ANY OTHER SYSTEM.

CONDUCTOR INSULATION. ALL WIRING SHALL BE INSTALLED BEFORE FINISHES ARE APPLIED TO WALL AND CEILING SURFACES.

WIRES & CABLES

ALL WIRE AND CABLE SHALL CONFORM TO THE LATEST REQUIREMENTS OF THE CURRENT EDITION OF THE NEC AND SHALL MEET ALL ASTM SPECIFICATIONS. WIRE AND CABLE SHALL BE NEW; SHALL HAVE SIZE, GRADE OF INSULATION, VOLTAGE AND MANUFACTURER'S NAME PERMANENTLY MARKED ON OUTER COVERING AT REGULAR INTERVALS; SHALL BE DELIVERED IN COMPLETE COILS OR REELS WITH IDENTIFYING SIZE AND INSULATION TAGS.

WIRE AND CABLE SHALL BE SUITABLY PROTECTED FROM WEATHER AND DAMAGE DURING STORAGE AND HANDLING AND SHALL BE IN FIRST-CLASS CONDITION WHEN INSTALLED.

ALL WIRING SHALL BE THHN, THWN, XHHW OR TYPE THW UNLESS A HIGHER TEMPERATURE WIRE IS REQUIRED TO FEED LIGHTING FIXTURES, HIGH TEMPERATURE CUTOUTS, ETC.

ALL CONDUCTORS SHALL BE STRANDED, SOFT-DRAWN COPPER UNLESS OTHERWISE NOTED. WIRE AND CABLE SHALL BE AS MANUFACTURED BY SOUTHWIRE, GENERAL CABLE, OKONITE OR ANACONDA.

MINIMUM SIZE WIRE SHALL BE #12 AWG UNLESS OTHERWISE NOTED. PROVIDE A SEPARATE NEUTRAL CONDUCTOR FOR EACH CIRCUIT.

WIRE CONNECTORS

SPLICES IN CONDUCTORS NO. 8 AND SMALLER SHALL BE MADE BY PREINSULATED "SCOTCH- LOCK" OR IDEAL "WING-NUT" SPRING TENSION CONNECTORS, INSTALLED IN STRICT ACCORDANCE WITH MANUFACTURER'S RECOMMENDATIONS. SPLICES OF NO. 6 CONDUCTORS AND LARGER SHALL BE MADE WITH SOLDERLESS, COMPRESSION TYPE CONNECTORS, U.L. LABELED AND COMPRESSED WITH APPROVED TOOLS.

EQUIVALENT OF THE CONDUCTOR INSULATION. WIRING DEVICES

GENERAL PURPOSE WIRING DEVICES: COMPLY WITH NEMA WD1. RECEPTACLES: UL 498, HEAVY-DUTY GRADE EXCEPT AS INDICATED OTHERWISE.

GROUND-FAULT CIRCUIT INTERRUPTER RECEPTACLES: UL 943, FEED-THROUGH TYPE, WITH INTEGRAL NEMA

5-20R DUPLEX RECEPTACLE; FOR INSTALLATION IN A 2 3/4 INCH DEEP OUTLET BOX WITHOUT AN ADAPTER.

SNAP SWITCHES: QUIET-TYPE AC TOGGLE SWITCHES, 120/277V., 20A., COMPLYING WITH UL 20.

AND BROWN IN MECHANICAL SPACES, UNLESS OTHERWISE NOTED.

ACCEPTABLE MANUFACTURERS OF GENERAL PURPOSE WIRING DEVICES ARE AS FOLLOWS: ARROW-HART, BRYANT, HUBBELL, PASS & SEYMOUR, AND LEVITON

INSTALL DEVICES AND ASSEMBLIES PLUMB AND SECURE. MOUNT DEVICES FLUSH, WITH LONG DIMENSION VERTICAL, AND GROUNDING TERMINAL OF RECEPTACLES ON BOTTOM. GROUP ADJACENT SWITCHES USING MULTIGANG WALL OUTLET BOXES. DO NOT USE GANGABLE TYPE BOXES.

LABELING

CIRCUIT ORIGINATION OR LOAD SERVED (AS APPROPRIATE). NAME PLATES SHALL BE SECURED TO PANELBOARDS, SAFETY SWITCHES, ENCLOSED CIRCUIT BREAKERS, IN CONSPICUOUS LOCATION.

ALL CIRCUITS AND OTHER EQUIPMENT SHALL BE SELECTED IN RATINGS IN ACCORDANCE WITH THE NATIONAL ELECTRICAL CODE, TO PROVIDE A COORDINATED SYSTEM OF OVER-CURRENT PROTECTION. THUS IN CASE OF A FAULT OR HARMFUL OVERLOAD, ONLY THE FUSES NEAREST THE FAULT OR OVERLOADED EQUIPMENT SHALL OPEN.

PANELBOARDS PANELBOARDS SHALL CONFORM TO THE LATEST NEMA, UL, AND NEC STANDARDS AND THE FLOOWING RATINGS AND DATA

SHALL BE DEAD FRONT TYPE WITH FLUSH OR SURFACE MOUNTED GALVANIZED STEEL CABINET PRIME COATED WITH AN INTERNAL ASSEMBLY OF CIRCUIT BREAKERS. TRIM SHALL HAVE HINGED AND LOCKED DOOR WITH HEAVY PLASTIC COVERED CIRCUIT DIRECTORIES, TO ALSO INDICATE VOLTAGE, PHASE, AND CAPACITY AS INDICATED ON DRAWINGS. ALL LOCKS SHALL BE KEYED ALIKE. FRONT ASSEMBLIES SHALL BE PAINTED WITH A PRIME AND FINISH COAT OF MANUFACTURES STANDARD FINISH. PANELS SHALL HAVE MAIN LUGS OR MAIN CIRCUIT BREAKER AS INDICATED ON DRAWINGS

CIRCUIT BREAKERS SHALL BE MOLDED PLASTIC CASE TYPE, AC RATED, BOLT ON, QUICK-MAKE, QUICK-BREAK, WITH TRIP FREE COMMON OPERATING HANDLE, POSITION INDICATION, AND COMMON TRIP FOR 2 AND 3 POLE CIRCUIT BREAKERS FROM THERMAL-MAGNETIC TRIP DEVICE. TRIP RATINGS AND NUMBER OF POLES SHALL BE AS INDICATED ON THE DRAWINGS AND MINIMUM INTERRUPTING CAPACITY SHALL BE 10,000 SYMMETRICAL AMPERES AT 120/240 VOLTS, AND 18,000 SYMMETRICAL AMPERES AT 277/480 VOLTS.

PANELBOARD DIRECTORIES SHALL DESIGNATE THE LIGHTING FIXTURES, ETC. CONTROLLED BY EACH BRANCH CIRCUIT IN THE PANEL. THE REQUIRED INFORMATION SHALL BE NEATLY TYPEWRITTEN ON DIRECTORIES IN EACH PANEL CIRCUIT.

PANELBOARDS SHALL BE UL LISTED. MAIN BUS BAR SHALL EXTEND THE FULL HEIGHT OF THE ENCLOSURE BEING PROVIDED REGARDLESS OF THE BRANCH CIRCUITS POSITIONS BEING CALLED FOR ON THE SCHEDULES

ACCEPTABLE MANUFACTURES OF PANELBOARDS INCLUDE SQUARE D, SEIMENS - I.T.E., EATON CULTER HAMMER, AND GENERAL ELECTRIC.

TEST AND ADJUSTMENTS ALL ELECTRICAL CIRCUITS SHALL BE TESTED AS SOON AS CONDUCTORS ARE INSTALLED, AND FINAL TESTS SHALL BE MADE IN THE PRESENCE OF THE OWNER'S REPRESENTATIVE WHEN ALL WORK IS COMPLETE, IF REQUIRED. IF CIRCUITS ARE NOT PROPERLY CONTROLLED AND INSULATED, MAKE NECESSARY CHANGES AND REPAIRS.

LIGHTING FIXTURES ARE TO BE PROVIDED AS SPECIFIED IN THE LIGHTING FIXTURE SCHEDULE ON THESE DOCUMENTS. FIXTURES SUBMITTALS ARE TO BE APPROVED BY THE ENGINEER PRIOR TO THE PURCHASE OF SAID DEVICES. ANY COSTS INCURRED IN THE ORDERING OF FIXTURES PRIOR TO ENGINEER'S AUTHORIZATION ARE THE RESPONSIBILITY OF THE CONTRACTOR.

OCCUPANCY SENSORS ARE TO BE OF THE TECHNOLOGY NOTED ON THE PLANS, WITH MOUNTING LOCATIONS SPECIFIC TO PRODUCT CAPABILITIES FOR FULL COVERAGE OF THE SPACE. SENSORS TO BE PROVIDED WITH TECHNOLOGY TO RESPOND ONLY TO MOVING BODIES (AND NOT NOISE OR AIR MOVEMENT) TO AVOID IMPROPER OPERATION. DEVICES ARE TO BE EQUIPPED FOR AUTOMATIC TIME DELAY AND SENSITIVITY SETTINGS. APPROVED MANUFACTURERS INCLUDE WATTSTOPPER, LC&D, LEVITON, SENSOR SWITCH.

ALL PARTS AND DEVICES NECESSARY FOR THE INSTALLATION AND OPERATION OF THE SPECIFIED LIGHTING FIXTURES AND CONTROL SYSTEMS ARE TO BE PROVIDED BY THE CONTRACTOR AS A COMPLETE SYSTEM, IN FULL WORKING ORDER. ANY LAMPS NOT OPERATIONAL MUST BE REPLACED PRIOR TO FINAL BUY-OFF.

GENERAL NOTES:

SWITCHES.

WIRE ALL EXIT/EMERGENCY LIGHTS TO THE SAME CIRCUIT AS NORMAL LIGHTING IN THEIR RESPECTIVE AREAS CONNECTED AHEAD OF ANY SWITCHES.

BRANCH CIRCUIT WIRING GREATER THAN 100' FROM ELECTRIC PANEL TO OUTLET/FIXTURE TO BE INCREASED IN SIZE TO COMPENSATE FOR VOLTAGE DROP.

EMERGENCY LIGHT FIXTURES TO BE PROVIDED WITH WIRING AND/OR EQUIPMENT SO THAT FIXTURE CAN BE SWITCHED, NOT BE A NIGHT LIGHT AND HAVE THE EMERGENCY BATTERY PACK OPERATOR LAMP DURING POWER FAILURE ONLY. PROVIDE UL924 LISTED POWER TRANSFER CONTROL SWITCH EQUAL TO LVS MOD. EPC-A TO ALLOW DESIGNATED EMERGENCY LIGHTING FIXTURES TO ILLUMINATE AUTOMATICALLY REGARDLESS OF ROOM SWITCH/OCCUPANCY SENSOR ON/OFF POSITION TO COMPLY WITH LIFE SAFETY CODE REQUIREMENTS.

PROVIDE EXTERIOR MOUNTED PHOTOCELL SWITCH TO OPERATE EXTERIOR FIXTURES.

NOTE PROVIDE NICKEL-CADMIUM BATTERY PACKS FOR LED LIGHT FIXTURES NOTED TO BE EMERGENCY LIGHT FIXTURES CAPABLE OF 1 1/2 HR MIN LIGHT OPERATION AND WITH FIXTURE MTD TEST SWITCH. WIRE ALL NIGHT LIGHTS, EXIT AND EMERGENCY LIGHTS TO THE NEAREST LIGHT CIRCUIT AHEAD OF ANY SWITCHES.

ALL ROOMS TO HAVE WALL MTD OCCUPANCY SENSORS TO CONTROL LIGHTING WHERE SWITCHES ARE SHOWN. SUITES AND CORRIDORS TO HAVE CEILING MTD OCCUPANCY SENSORS.

INSTALLATION OF CABLES BEFORE CONDUCTORS ARE INSTALLED IN CONDUIT RUNS, THE CONDUITS SHALL BE SWABBED OR THE EQUIVALENT TO ENSURE THEIR DRYNESS AND FREEDOM FROM FOREIGN MATTER DETRIMENTAL TO THE

ALL SPLICES SHALL BE INSULATED WITH AN APPROVED VINYL PLASTIC ALL WEATHER TAPE TO A THICKNESS

DEVICE BODIES SHALL BE WHITE FOR GENERAL USE DEVICES, ORANGE FOR ISOLATED GROUND RECEPTACLES,


NAME PLATES SHALL INCLUDE THE FOLLOWING INFORMATION - EQUIPMENT IDENTIFICATION, CIRCUIT NUMBER,

TIME SWITCHES ARE TO BE ELECTRONIC, WITH INTERNAL RELAY CAPABLE OF SWITCHING CIRCUIT LOADS. TIMING ELEMENT TO BE SELECTABLE FROM 5 MINUTES TO 1 HOUR, IN NO MORE THAN 20 MINUTE INTERVALS.


FIXTURES WITH THE NL SYMBOL ARE NIGHT LIGHT FIXTURES AND ARE TO BE HARDWIRED AHEAD OF ANY LOCAL

LIGHTING FIXTURE SCHEDULE

A 'LITHONIA'	2FSL4 48L EZ1 LP835	2'X4' LED RE ROLLED STE WHITE LENS DRIVER 1 - 4
A1		SAME AS A
B 'JUNO'	TC22LED G4 14LM 35K 90CRI MVOLT EZ1	6" DIAMETE REFLECTOF MOUNTING I 1400 LUMEN
C 'FLUXWERX'	TC1 P09 R 12 B W2835 28W E1 M	PENDENT M WIDE BEAM S REMOTE DRI
C1		SAME AS C (
D 'FLUXWERX'	TC1 T05 R J1 BB M1835 21W E1 M	SURFACE M MEDIUM BEA REMOTE DRI
D1		SAME AS D C
E 'LITHONIA'	ZL1N L24 3500LM FST MVOLT 35K 80CRI WH	CABLE MTD L BAKED WHI DRIVER LAN
EX 'LITHONIA'	EXR LED EL M6	EXIT LIGHT V DIRECTIONA NI CAD EME SHOWN
EM 'LITHONIA'	ELM6L	

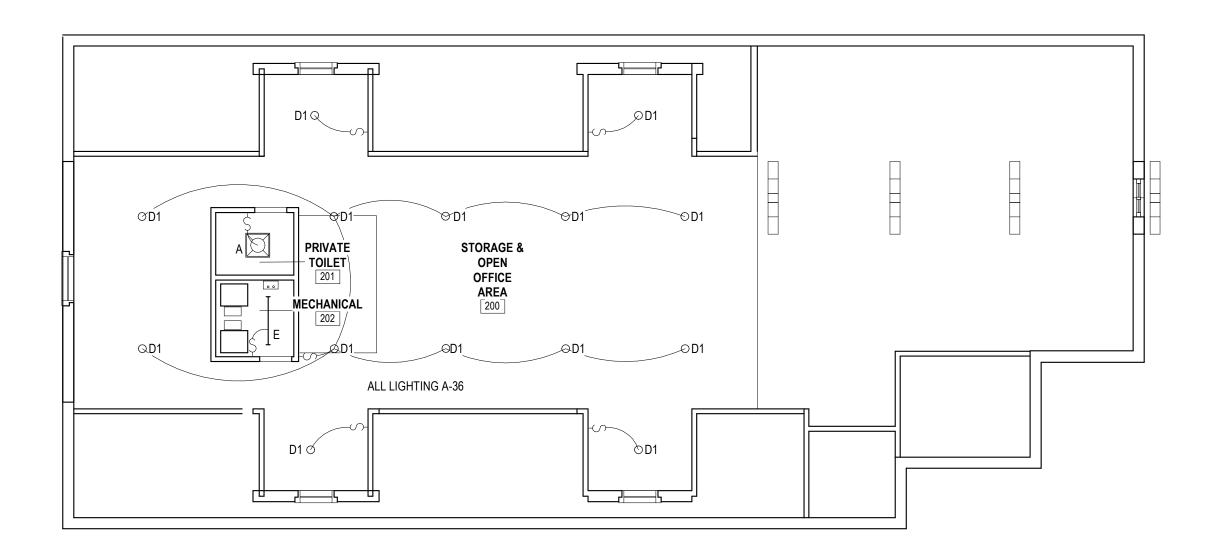



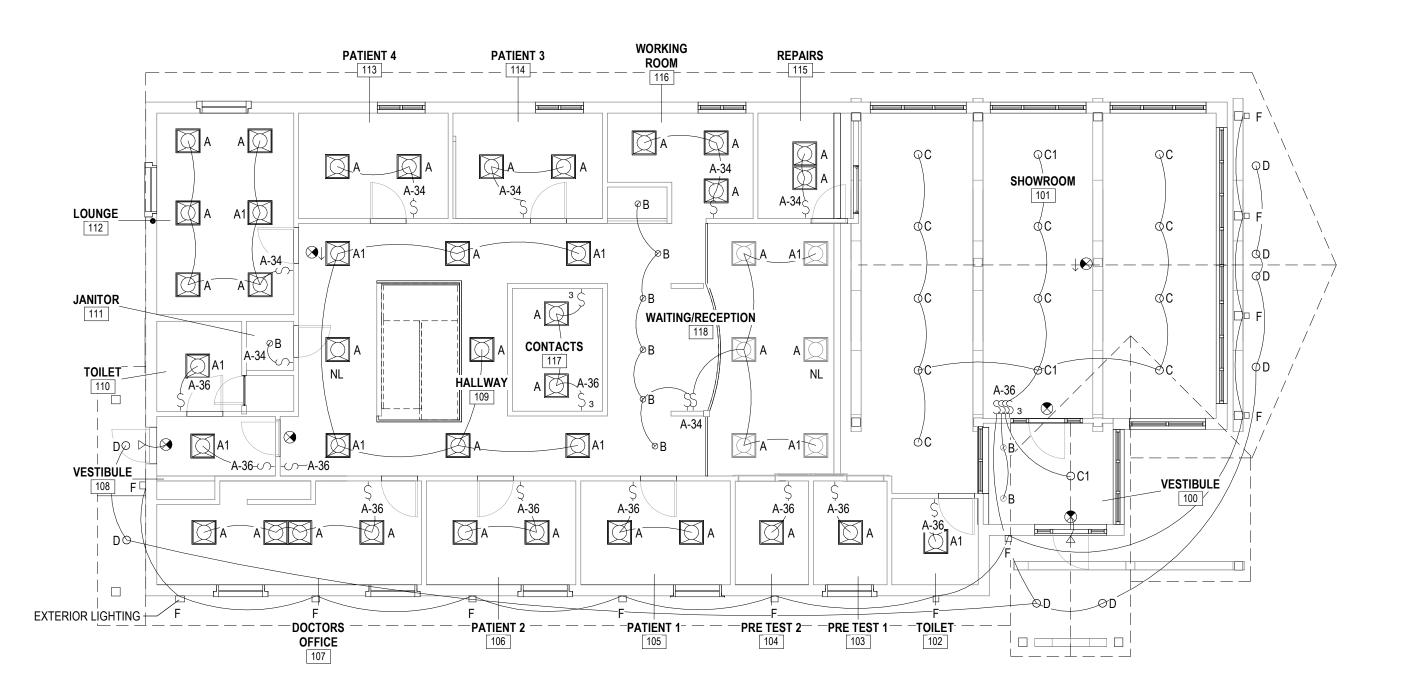



ECESSED BASKET STYLE TROFFER, WITH ONE-PIECE COLD EEL HOUSING WITH COATED POLYESTER PAINTED WHITE FINISH, SATIN S, UNIVERSAL MVOLT ELECTRONIC DRIVER, 4800 LUMENS AND DIMMING 47 WATT LED LAMP

ONLY EMERGENCY LIGHT WITH 90 MIN BATTERY BACK UP R LED RECESSED DOWNLIGHT WITH SELF FLANGED SEMI SPECULAR R FINISH 16 GA UGE GALVANIZED STEEL HOUSING, 1.0 SPACING TO HEIGHT LIGHT DISTRIBUTION, 120 VOLT, ELECTRONIC DRIVER, NS, AND CLEAR APERATURE/TRIM COLOR. 1 - 18 WATT LED LAMP

ITD 9" ROUND LED LAMP BLACK WITH 20%UP AND 80% DN LIGHT DISTRIBUTION SPREAD, 80 CRI, 3500K, 28 WATT, 4000 LUMENS, ELDOLED ECO 0-10V DIM 1%

ONLY EMERGENCY LIGHT WITH 90 MIN BATTERY BACK UP MTD 5.5" ROUND LED LAMP BLACK WITH ADJUSTABLE BEAM DISTRIBUTION, AM SPREAD, 80 CRI, 3500K, 21 WATT, 2960 LUMENS, ELDOLED ECO 0-10V DIM 1%


ONLY WIDE BEAM DISTRIBUTION LOW PROFILE 'Z' STRIP CHANNEL LED FIXTURE COLD ROLLED STL, HIGH GLOSS TE ENAMELWITH STRAIGHT BLAD LOUVRE MULTI-VOLT IMPUT 0-10V DIMMING MP 80CRI AT 3500 K 3500 LUMENS 31 WATTS


WALL/CEILING MOUNTED WHITE THERMOPLASTIC HOUSING RED LETTER, IAL ARROW KNOCK OUTS SINGLE OR DOUBLE FACED 120V WITH 90 MIN RGENCY BATTERY PACK , REMOTE HEAD ELA Q WITH L0309 LED LAMP WHERE

CY LIGHT WALL/CEILING MOUNTED WHITE THERMOPLASTIC HOUSING, WITH 90 MIN NI CAD EMERGENCY BATTERY PACK 1000 LUMENS





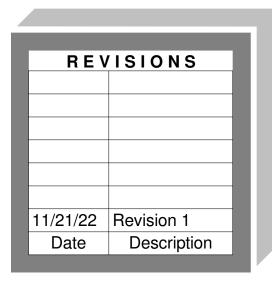

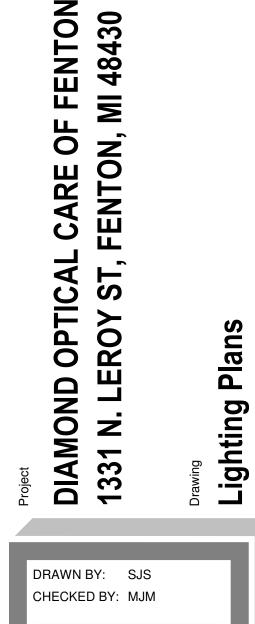

PROJECT NUMBER 21-041 DATE 10/25/2022 SCALE As indicated SHEET NUMBER